65% Engineer's E		65% Engineer's Est	imate	
Project:	HB Visitor Center Pa	HB Visitor Center Parking Lot		
Owner:	Haines Borough			
Date:	3/29/2024			
Prepared By:	E. Roemeling			
Checked By:	L. Chambers			



	Base Bid				
Pay Item	Pay Item Description	Pay Unit	Quantity	Unit Price	Amount
202.0002.000A	Removal of Pavement, Asphalt	SY	1032	\$6.00	\$6,192.00
203.0003.0000	Unclassified Excavation	CY	72	\$25.00	\$1,800.00
301.0002.00D1	Aggregate Base Course, Grading D-1	CY	82	\$120.00	\$9,840.00
401.0001.002B	HMA Type II; Class B	TON	183	\$300.00	\$54,900.00
401.0004.5834	Asphalt Binder, Grade PG 58-34	TON	11	\$1,800.00	\$19,800.00
603.0021.0018	Corrugated Polyethylene Pipe 18 Inch	LF	29	\$135.00	\$3,915.00
604.0017.0000	Connect to Existing Storm Drain Manhole	Each	1	\$5,000.00	\$5,000.00
604.0005.000A	Inlet, Type IV w/ Concrete Area Drain	Each	1	\$9,000.00	\$9,000.00
615.0008.0000	Signing	Lump Sum	All Req'd	\$5,000.00	\$5,000.00
640.0001.0000	Mobilization and Demobilization	Lump Sum	All Req'd	\$21,000.00	\$21,000.00
641.0003.0000	Temporary Erosion, Sediment and Pollution Control	Lump Sum	All Req'd	\$3,000.00	\$3,000.00
642.0001.0000	Construction Surveying	Lump Sum	All Req'd	\$4,000.00	\$4,000.00
642.0013.0000	Additional Construction Surveying	HR	10	\$150.00	\$1,500.00
670.0001.0001	Painted Traffic Markings	Lump Sum	All Req'd	\$15,000.00	\$15,000.00
				Subtotal =	\$159,947.00
		10% Construction Contingency =		\$15,994.70	
				Total =	\$175,941.70


HAINES BOROUGH VISITOR CENTER PARKING LOT

SHEET INDEX

SHEET NO. DESCRIPTION

1 COVER SHEET
2 LEGEND ABBREVIATIONS GENERAL NOTES
3 EXISTING SITE CONDITIONS
4 SITE PLAN
5 CONSTRUCTION DETAILS

HAINES BOROUGH, ALASKA

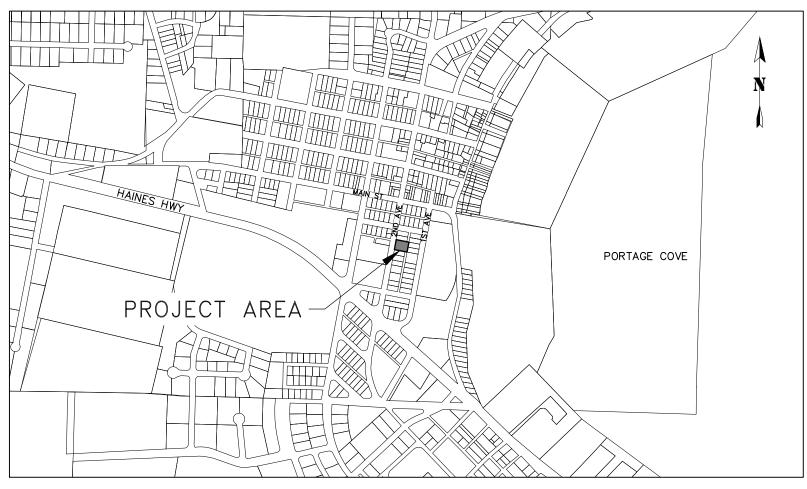

BERING SEA

BETHEL

ANCHORAGE

HAINES

BETHEL

SITKA

WETCHIKAN

ALASKA

PROJECT LOCATION MAP

NTS

VICINITY MAP

			RECORD OF REVISIONS		
1	No.	DATE	DESCRIPTION	BY	1
C Cunt					
OF REVEN					_



	DRAWN BY:	E. ROEMELING			
	DESIGNED BY:	E. ROEMELING			
	CHECKED BY:	L. CHAMBERS			
•	219 MAIN ST #13 HAINES, AK 99827 1945 ALEX HOLDEN WAY #101 JUNEAU, AK 99801 (907) 780-4004				



5TH TO 6TH AVENUE DRAINAGE IMPROVEMENTS

COVER SHEET

SHEET NUMBER

1

OF

5

RECORD OF REVISIONS

DESCRIPTION

_EGEND

ABBREVIATIONS

AC BOP ASPHALT CONCRETE BEGINNING OF PROJECT BTM воттом CB CATCH BASIN CENTERLINE СMР CORRUGATED METAL PIPE CORRUGATED POLYETHYENE PIPE CPP CONC CTE CONCRETE CONNECT TO EXISTING DIP DUCTILE IRON PIPE DIA DIAMETER FDGE OF ASPHALT **FI EVATION** END OF PROJECT FOF **EXISTING** ΕX FG FINISHED GRADE FIRE HYDRANT GATE VALVE HAINES BOROUGH HIGH DENSITY POLYETHYLENE HDPE INVERT ELEVATION INV LT LENGTH OF VERTICAL CURVE LVC MANHOLE MINIMUM MIN MATCH TO EXISTING MTE NIC NOT IN CONTRACT NO NUMBER NTS NOT TO SCALE OD OUTSIDE DIAMETER OHE PSI PVI OVERHEAD FLECTRIC POUNDS PER SQUARE INCH POLYVINYL CHLORIDE PIPE RP RADIUS POINT RIGHT RIGHT-OF-WAY STORM DRAIN MANHOLF SDMH SSMH STA SANITARY SEWER MANHOLE STATION STANDARD STD TBC TOP BACK OF CURB TOP BACK OF GUTTER TEMPORARY BENCHMARK TOP OF PAVEMENT TP TYP **TYPICAL**

GENERAL NOTES

- 1. ALL WORK FOR THESE PLANS SHALL BE CONDUCTED IN STRICT ACCORDANCE WITH ALL APPLICABLE LOCAL, STATE AND FEDERAL LAWS AND STANDARDS.
- 2. LOCATIONS AND ELEVATION OF EXISTING UNDERGROUND WATER, SEWER, POWER, TELEPHONE AND CABLE TELEVISION SHOWN ON THE PLANS WERE DERIVED FROM HAINES BOROUGH AS—BUILTS AND FIELD LOCATES. THE ACTUAL LOCATION OF UTILITIES MAY VARY FROM THOSE SHOWN. THE CONTRACTOR IS RESPONSIBLE FOR LOCATING, PROTECTING AND MAINTAINING EXISTING UTILITIES THROUGHOUT THE CONSTRUCTION OF THE PROJECT. ANY DAMAGE TO UTILITIES DURING CONSTRUCTION SHALL BE PAID FOR BY THE CONTRACTOR AND SHALL BE CONSIDERED INCIDENTAL TO THE CONTRACT. THE CONTRACTOR SHALL CONTACT AND REQUEST UTILITY LOCATES, AT A MINIMUM, FROM THE FOLLOWING PRIOR TO BEGINNING EARTH DISTURBING ACTIVITIES:
 - A) HAINES BOROUGH PUBLIC FACILITIES, 907-766-6414.
 - B) ALASKA POWER & TELEPHONE(AP&T), 907-766-6500.
 - C) HAINES CABLE TV. 907-766-2337.
- 3. A GEOTECHNICAL INVESTIGATION WAS NOT PERFORMED AS PART OF THIS DESIGN. HARDPAN, CLAY, GROUNDWATER, LARGE BOULDERS, BEDROCK, STUMPS, LOGS, ORGANICS, AND OTHER NATIVE MATERIALS MAY BE ENCOUNTERED AT VARIOUS DEPTHS DURING TRENCHING AND SITE GRADING OPERATIONS.
- 4. THE TOTAL DISTURBED AREA FOR THIS PROJECT IS ANTICIPATED TO BE LESS THAN ONE ACRE.
- 5. ALL DISTURBED AREAS SHALL BE RESTORED TO EXISTING CONDITIONS AND GRADES, AND STABILIZED WITH AN APPROVED HYDRAULIC GROWTH MEDIUM AND GRASS SEED UNLESS OTHERWISE SHOWN ON THE PLANS.
- 6. CONTRACTOR SHALL ENSURE GARBAGE PICKUP, PRIVATE AND BUSINESS DELIVERIES, AND DAILY MAIL SERVICE WILL BE UNINTERRUPTED TO ALL BUSINESS AND RESIDENCES AFFECTED BY THIS PROJECT.
- 7. THE CONTRACTOR SHALL NOTIFY EACH PROPERTY OWNER OF DRIVEWAY CLOSURE 48 HOURS PRECEDING THE DAY THE DRIVEWAY IS TO BE CLOSED TO VEHICULAR ACCESS. THE PROPERTY OWNER SHALL BE INFORMED OF THE PERIOD OF TIME THE CLOSURE WILL BE IN EFFECT. NO DRIVEWAY CLOSURES WILL BE PERMITTED UNTIL THIS REQUIREMENT HAS BEEN MET TO THE SATISFACTION OF THE ENGINEER.
- 8. THE CONTRACTOR SHALL NOT STORE MATERIALS OR EQUIPMENT, OR OPERATE EQUIPMENT WITH ITS TRACKS OR WHEELS PLACED ON PRIVATE PROPERTY, WITHOUT THE APPROVAL OF THE PROPERTY OWNER.
- 9. THE PLAN DRAWINGS DO NOT SHOW ALL PLANTINGS, AND OTHER LANDSCAPING THAT WILL BE ENCOUNTERED DURING CONSTRUCTION ACTIVITIES. NO PLANTINGS OR LANDSCAPING ARE TO BE REMOVED OR DAMAGED, UNLESS SHOWN ON THE DRAWINGS OR DIRECTED BY THE ENGINEER.
- 10. ALL ITEMS DESIGNATED TO BE REMOVED SHALL BE DISPOSED OF OFF-SITE, EXCEPT AS NOTED IN THE CONTRACT DOCUMENTS.
 ALL OTHER MATERIALS TO BE REMOVED AND DISPOSED OF SHALL BECOME THE PROPERTY OF THE CONTRACTOR, INCLUDING CONCRETE, ASPHALT, UNSUITABLE SOILS AND ETC.
- 11. WORK SHALL BE PERFORMED MONDAY THROUGH FRIDAY, 8AM TO 5PM ONLY.

TRAFFIC CONTROL NOTES

- 1. ALL TRAFFIC TO BE CONTROLLED PER REQUIREMENTS OF THE ALASKA TRAFFIC MANUAL, U.S. DEPARTMENT OF TRANSPORTATION "MANUAL ON UNIFORM TRAFFIC CONTROL DEVICES" AND THE ALASKA SUPPLEMENT.
- 2. MAINTAIN ONE (1) LANE FOR TRAFFIC AT ALL TIMES UNLESS OTHERWISE APPROVED BY THE ENGINEER.
- 3. NOTIFICATION OF WORK THAT MAY IMPEDE TRAFFIC MUST BE PROVIDED TO THE HB PUBLIC WORKS DEPARTMENT, HB POLICE DEPARTMENT, HAINES VOLUNTEER FIRE DEPARTMENT, CHILKOOT INDIAN ASSOCIATION, ALASKA DOT&PF HAINES M&O FOREMAN, AND THE GENERAL PUBLIC A MINIMUM OF 72 HOURS IN ADVANCE OF IMPLEMENTING TRAFFIC CONTROL.
- 4. CONTRACTOR MUST PROVIDE ALL NECESSARY SIGNS AND TRAFFIC CONTROL DEVICES TO MOVE TRAFFIC THROUGH OR AROUND THE PROJECT SITE.
- 5. PROVIDE ACCESS FOR EMERGENCY VEHICLES AT ALL TIMES.

No. No.

DATE

pro HNS LLC

CERTIFICATE OF AUTHORIZATION

DRAWN BY: E. ROEMELING
DESIGNED BY: E. ROEMELING
CHECKED BY: L. CHAMBERS

219 MAIN ST#13
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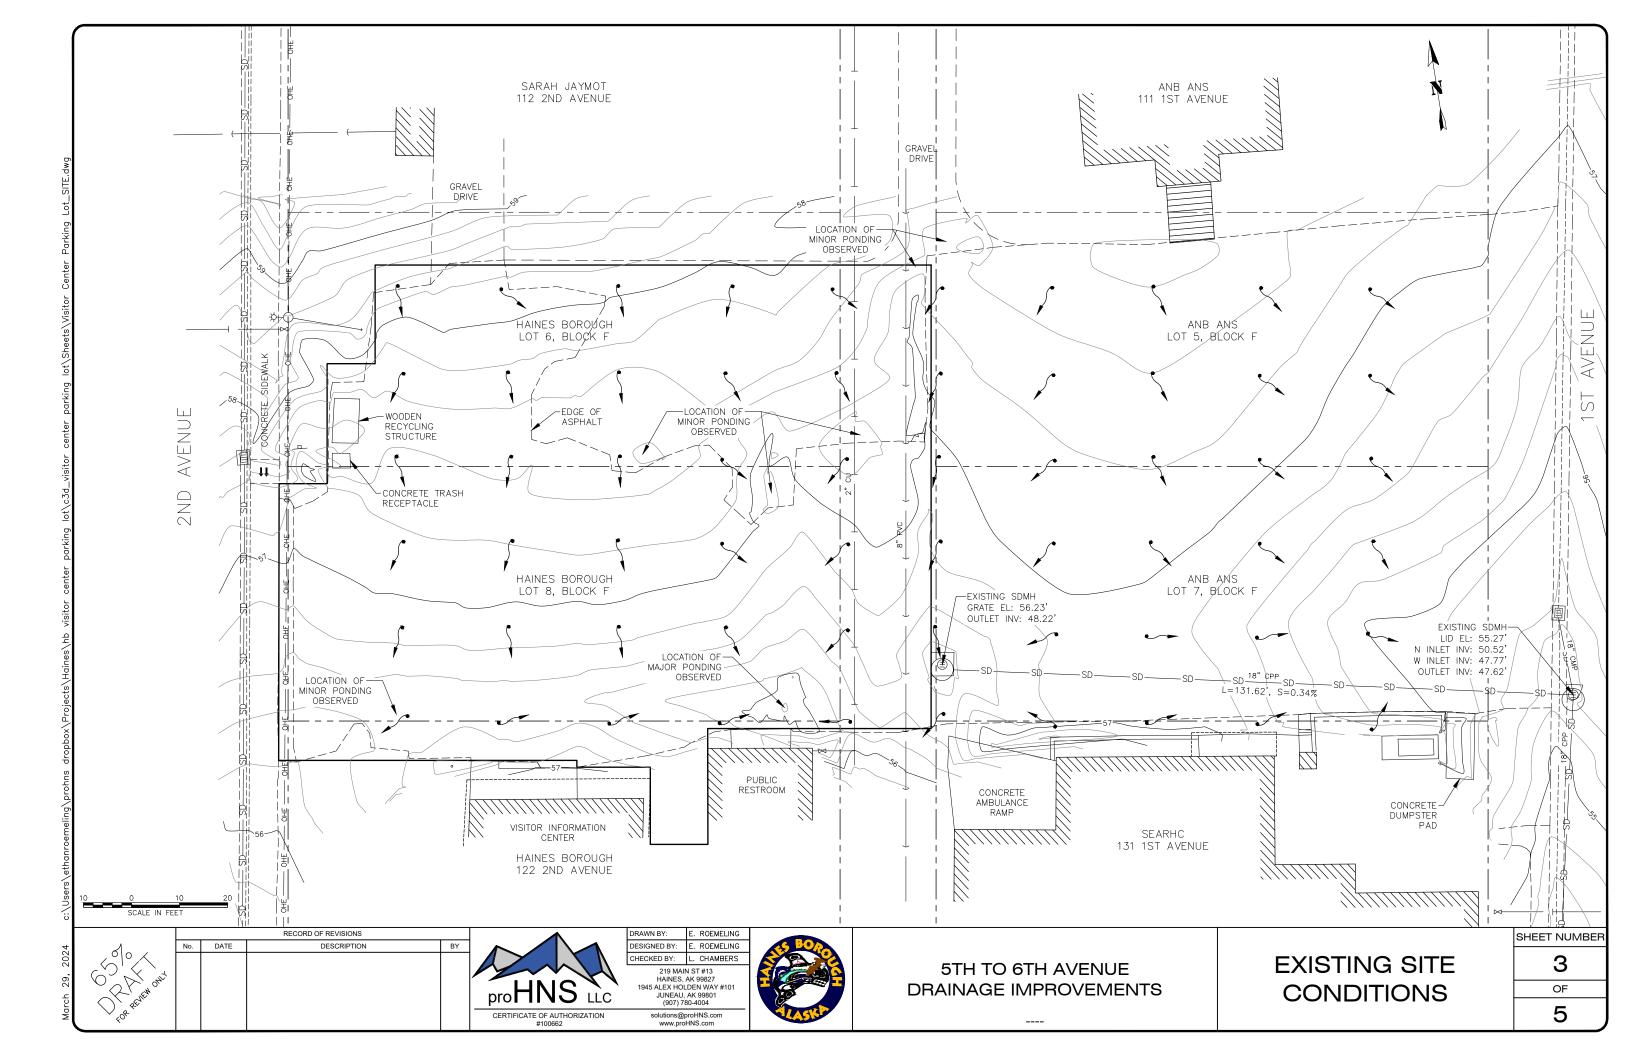



5TH TO 6TH AVENUE DRAINAGE IMPROVEMENTS

LEGEND ABBREVIATIONS GENERAL NOTES SHEET NUMBER

5

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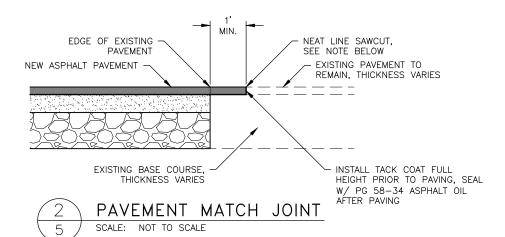


PARKING AREA TYPICAL SECTION

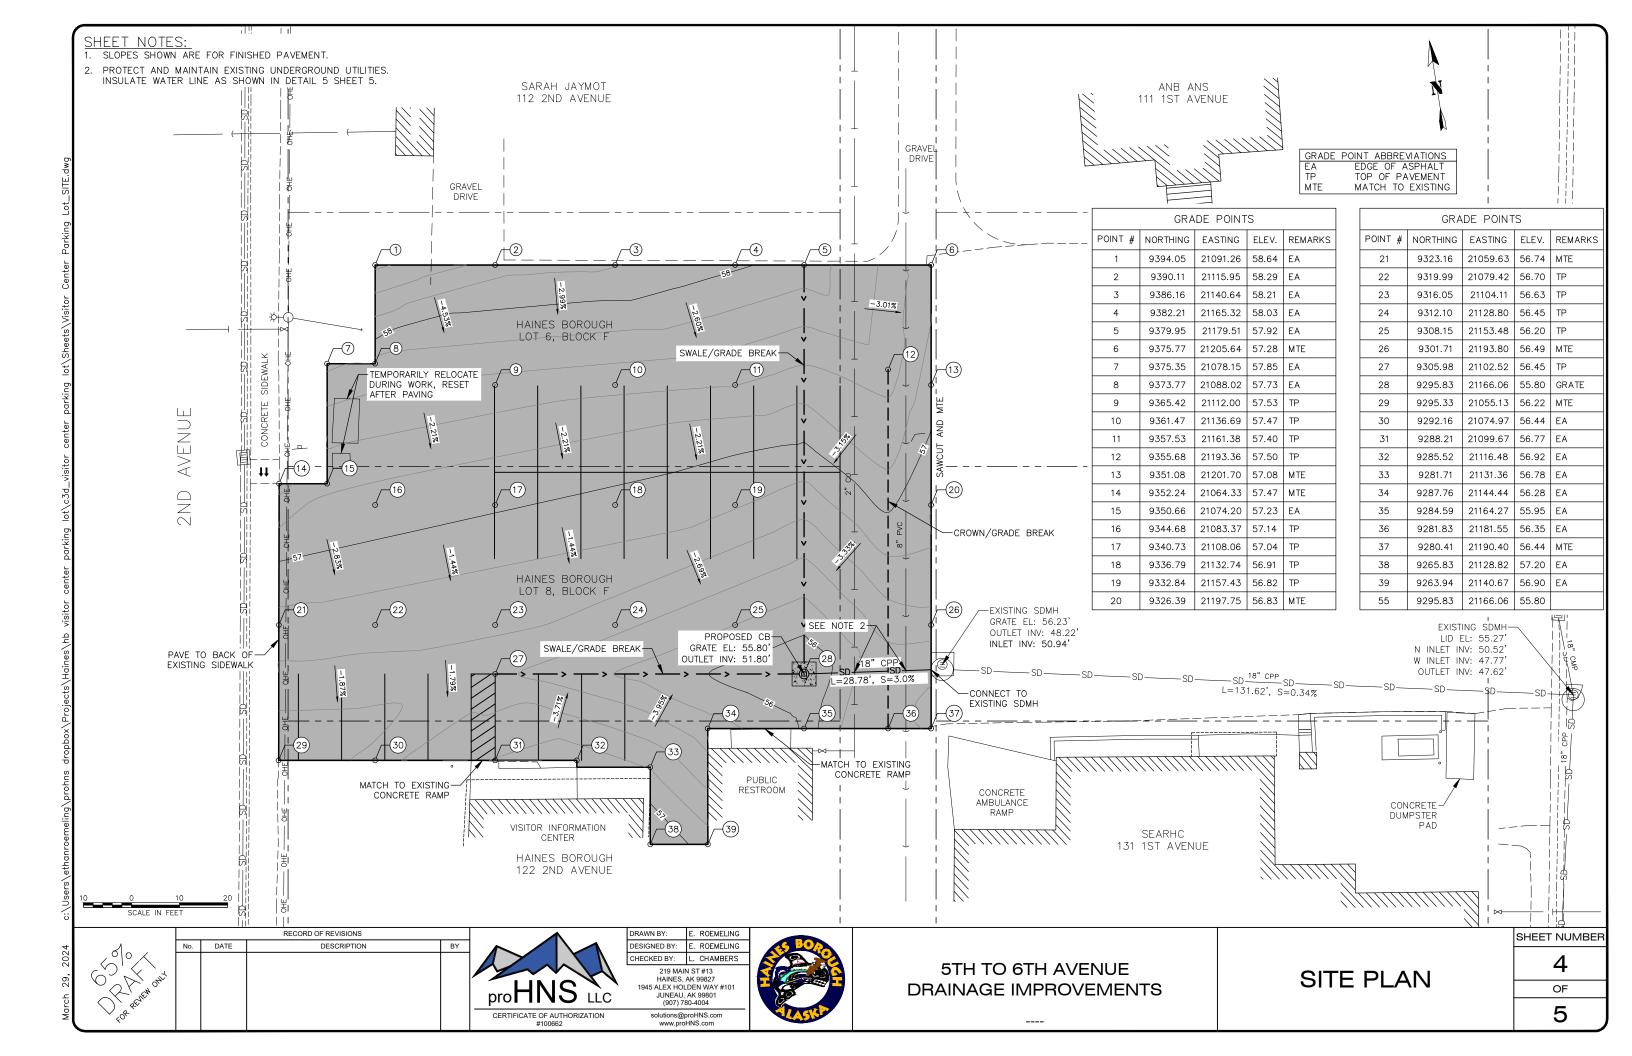SCALE: NOT TO SCALE


DETAIL 1/4 NOTES:

- COMPACT D-1 BASE COURSE TO MINIMUM 95% OF MODIFIED PROCTOR DENSITY (ASTM D1557)
- PROOF ROLL BOTTOM OF SUBCUT EXCAVATION SHALL BE PERFORMED USING A
 MINIMUM 10-TON SELF PROPELLED VIBRATORY COMPACTOR. A MINIMUM OF TWO (2)
 PASSES (ONE PASS EQUALS DOWN AND BACK) SHALL BE MADE OVER THE SUBCUT
 SOILS AND AS APPROVED BY THE ENGINEER.




DETAIL 1/4 NOTES:

 FINAL SAWCUT OF EXISTING ASPHALT SHALL NOT BE MADE UNTIL 24 HOURS PRIOR TO PAVING.

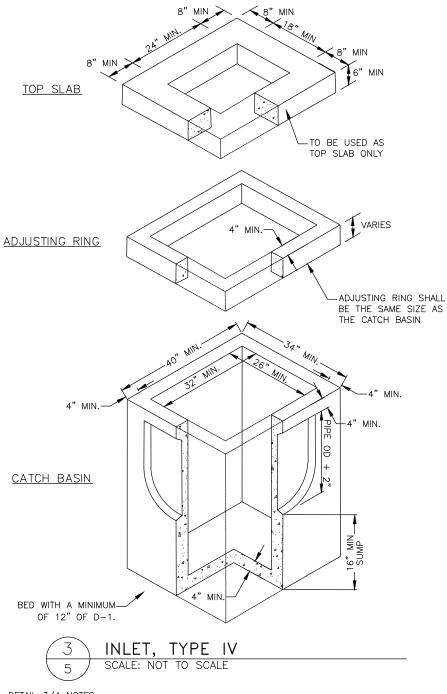


DETAIL 3/4 NOTES:


- 1. ENTIRE KNOCKOUT IS TO BE REMOVED AND SEALED SHUT AROUND PIPE. ALL PIPES ARE TO EXTEND MIN. 1" AND MAX. 2" INTO CATCH BASIN.
- 2. THE AREA BETWEEN THE TOP OF THE CATCH BASIN AND THE FRAME SHALL BE FORMED AND FILLED WITH CONCRETE OR NON-SHRINK GROUT. NO BRICKS, WOOD OR OTHER MATERIALS PERMITTED FOR ADJUSTING GRADE.
- 3. FRAME AND GRATE SHALL BE DUCTILE IRON. FRAME MAY BE CAST INTO THE TOP UNIT OR PLACED OVER THE OPENING AS APPROVED BY THE ENGINEER. FRAME AND GRATE MUST BE OF A TYPE THAT WILL NOT CREATE A HAZARD FOR BICYCLE TRAFFIC.
- 4. CATCH BASIN SHALL MEET HIGHWAY STANDARD-20 LOAD REQUIREMENTS
- 5. MINIMUM STEEL REQUIRED AS PER ASTM C-478-69.
- 6. MINIMUM SUMP DEPTH SHALL SHALL BE 16".

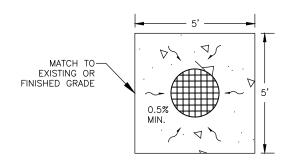

PLAN VIEW

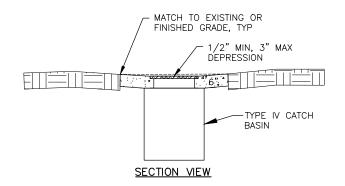

4 CONCRETE AREA DRAIN DETAIL 5 SCALE: NOT TO SCALE

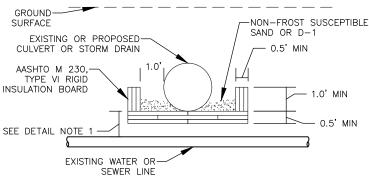

UTILITY CROSSING

5 WATER LINE INSULATION DETAILS 5 SCALE: NOT TO SCALE

DETAIL 3/5 NOTES:

- 1. INSTALL INSULATION AS SHOWN WHEN DISTANCE IS LESS THAN 6.0'.
- 2. PIPE INSULATION SHALL BE 8'-0" IN LENGTH, CENTERED OVER WATER LINE OR WATER SERVICE.
- 3. PIPE INSULATION WITH R-FACTOR EQUAL TO RIGID BOARD MAY BE SUBSTITUTED IF APPROVED BY THE ENGINEER.
- CROSSING SHALL BE PROTECTED WITH A MINIMUM 6" OF INSULATION BOARDS WITH A 12" OVERLAP, AS SHOWN.



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5TH TO 6TH AVENUE DRAINAGE IMPROVEMENTS CONSTRUCTION DETAILS

5 OF

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DETAILS