# HAINES BOROUGH VISITOR CENTER PARKING LOT

SHEET NO.

SHEET NO.

DESCRIPTION

1 COVER SHEET

2 LEGEND ABBREVIATIONS GENERAL NOTES


3 EXISTING SITE CONDITIONS

4 SITE PLAN

5 CONSTRUCTION DETAILS

6 SURVEY CONTROL SHEET

HAINES BOROUGH, ALASKA

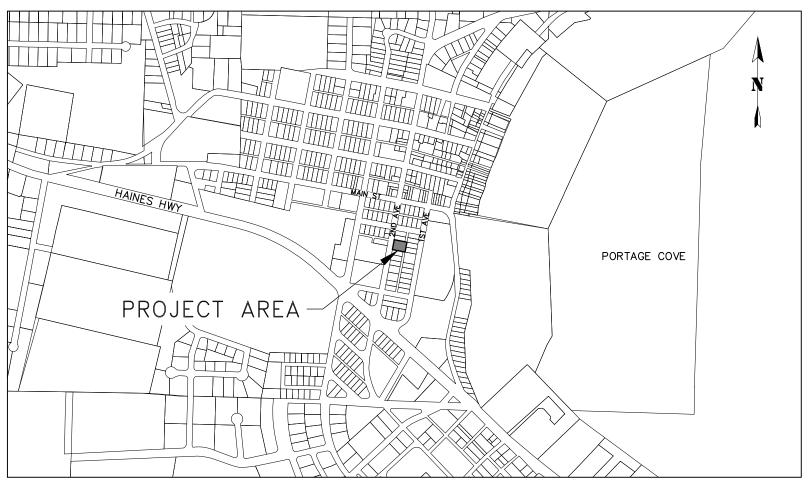

NOME FAIRBANKS

ANCHORAGE

BERING SEA

BERING SEA

ANCHORAGE

WODIAK

GULF OF ALASKA

ALASKA

ALASKA

PROJECT LOCATION MAP

VICINITY MAP

RECORD OF REVISIONS

No. DATE DESCRIPTION BY

OF REIGHT

proHNS LLC

CERTIFICATE OF AUTHORIZATION

MARGON AND AUTHORIZATION

DRAWN BY: E. ROEMELING
DESIGNED BY: E. ROEMELING
CHECKED BY: L. CHAMBERS

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HAINES, AK 99827
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HAINES BOROUGH VISITOR CENTER PARKING LOT

**COVER SHEET** 

SHEET NUMBER

1

OF

6

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# ABBREVIATIONS

AC BOP ASPHALT CONCRETE BEGINNING OF PROJECT BTM CB CATCH BASIN CENTERLINE CMP CORRUGATED METAL PIPE CORRUGATED POLYETHYENE PIPE CPP CONC CTE CONCRETE CONNECT TO EXISTING DIP DUCTILE IRON PIPE DIA DIAMETER FDGE OF ASPHALT **FI EVATION** END OF PROJECT FOF **EXISTING** FG FINISHED GRADE FIRE HYDRANT GATE VALVE HAINES BOROUGH HIGH DENSITY POLYETHYLENE HDPE INVERT ELEVATION INV LENGTH OF VERTICAL CURVE LVC MANHOLE MINIMUM MIN MATCH TO EXISTING MTE NIC NOT IN CONTRACT NO NUMBER NTS NOT TO SCALE OD OUTSIDE DIAMETER OHE PSI PVI OVERHEAD FLECTRIC POUNDS PER SQUARE INCH POLYVINYL CHLORIDE PIPE RP RADIUS POINT RIGHT RIGHT-OF-WAY STORM DRAIN MANHOLF SDMH SSMH STA SANITARY SEWER MANHOLE STATION STANDARD STD TBC TOP BACK OF CURB TOP BACK OF GUTTER TEMPORARY BENCHMARK TP TOP OF PAVEMENT TYP **TYPICAL** 

# GENERAL NOTES

- ALL WORK FOR THESE PLANS SHALL BE CONDUCTED IN STRICT ACCORDANCE WITH ALL APPLICABLE LOCAL, STATE AND FEDERAL LAWS AND STANDARDS
- LOCATIONS AND ELEVATION OF EXISTING UNDERGROUND WATER, SEWER, POWER, TELEPHONE AND CABLE TELEVISION SHOWN ON THE PLANS WERE DERIVED FROM HAINES BOROUGH AS—BUILTS AND FIELD LOCATES. THE ACTUAL LOCATION OF UTILITIES MAY VARY FROM THOSE SHOWN. THE CONTRACTOR IS RESPONSIBLE FOR LOCATING, PROTECTING AND MAINTAINING EXISTING UTILITIES THROUGHOUT THE CONSTRUCTION OF THE PROJECT. ANY DAMAGE TO UTILITIES DURING CONSTRUCTION SHALL BE PAID FOR BY THE CONTRACTOR AND SHALL BE CONSIDERED INCIDENTAL TO THE CONTRACT. THE CONTRACTOR SHALL CONTACT AND REQUEST UTILITY LOCATES, AT A MINIMUM, FROM THE FOLLOWING PRIOR TO BEGINNING EARTH DISTURBING ACTIVITIES:
  - A) HAINES BOROUGH PUBLIC FACILITIES, 907-766-6414.
  - B) ALASKA POWER & TELEPHONE(AP&T), 907-766-6500.
  - HAINES CABLE TV. 907-766-2337.
- A GEOTECHNICAL INVESTIGATION WAS NOT PERFORMED AS PART OF THIS DESIGN. HARDPAN, CLAY, GROUNDWATER, LARGE BOULDERS, BEDROCK, STUMPS, LOGS, ORGANICS, AND OTHER NATIVE MATERIALS MAY BE ENCOUNTERED AT VARIOUS DEPTHS DURING TRENCHING AND SITE GRADING OPERATIONS.
- 4. THE TOTAL DISTURBED AREA FOR THIS PROJECT IS ANTICIPATED TO BE LESS THAN ONE ACRE.
- ALL DISTURBED AREAS SHALL BE RESTORED TO EXISTING CONDITIONS AND GRADES, AND STABILIZED WITH AN APPROVED HYDRAULIC GROWTH MEDIUM AND GRASS SEED UNLESS OTHERWISE SHOWN ON THE PLANS.
- CONTRACTOR SHALL ENSURE GARBAGE PICKUP, PRIVATE AND BUSINESS DELIVERIES, AND DAILY MAIL SERVICE WILL BE UNINTERRUPTED TO ALL BUSINESS AND RESIDENCES AFFECTED BY THIS PROJECT.
- 7. THE CONTRACTOR SHALL NOTIFY EACH PROPERTY OWNER OF DRIVEWAY CLOSURE 48 HOURS PRECEDING THE DAY THE DRIVEWAY IS TO BE CLOSED TO VEHICULAR ACCESS. THE PROPERTY OWNER SHALL BE INFORMED OF THE PERIOD OF TIME THE CLOSURE WILL BE IN EFFECT. NO DRIVEWAY CLOSURES WILL BE PERMITTED UNTIL THIS REQUIREMENT HAS BEEN MET TO THE SATISFACTION OF THE ENGINEER
- THE CONTRACTOR SHALL NOT STORE MATERIALS OR EQUIPMENT, OR OPERATE EQUIPMENT WITH ITS TRACKS OR WHEELS PLACED ON PRIVATE PROPERTY, WITHOUT THE APPROVAL OF THE PROPERTY OWNER.
- THE PLAN DRAWINGS DO NOT SHOW ALL PLANTINGS, AND OTHER LANDSCAPING THAT WILL BE ENCOUNTERED DURING CONSTRUCTION ACTIVITIES. NO PLANTINGS OR LANDSCAPING ARE TO BE REMOVED OR DAMAGED, UNLESS SHOWN ON THE DRAWINGS OR DIRECTED BY THE ENGINEER
- 10. ALL ITEMS DESIGNATED TO BE REMOVED SHALL BE DISPOSED OF OFF-SITE, EXCEPT AS NOTED IN THE CONTRACT DOCUMENTS. ALL OTHER MATERIALS TO BE REMOVED AND DISPOSED OF SHALL BECOME THE PROPERTY OF THE CONTRACTOR, INCLUDING CONCRETE, ASPHALT, UNSUITABLE SOILS AND ETC.
- 11. WORK SHALL BE PERFORMED MONDAY THROUGH FRIDAY, 8AM TO 5PM ONLY.

# TRAFFIC CONTROL NOTES

- ALL TRAFFIC TO BE CONTROLLED PER REQUIREMENTS OF THE ALASKA TRAFFIC MANUAL, U.S. DEPARTMENT OF TRANSPORTATION "MANUAL ON UNIFORM TRAFFIC CONTROL DEVICES' AND THE ALASKA SUPPLEMENT.
- 2. MAINTAIN ONE (1) LANE FOR TRAFFIC AT ALL TIMES UNLESS OTHERWISE APPROVED BY THE ENGINEER.
- NOTIFICATION OF WORK THAT MAY IMPEDE TRAFFIC MUST BE PROVIDED TO THE HB PUBLIC WORKS DEPARTMENT, HB POLICE DEPARTMENT, HAINES VOLUNTEER FIRE DEPARTMENT, CHILKOOT INDIAN ASSOCIATION, ALASKA DOT&PF HAINES M&O FOREMAN, AND THE GENERAL PUBLIC A MINIMUM OF 72 HOURS IN ADVANCE OF IMPLEMENTING TRAFFIC CONTROL.
- 4. CONTRACTOR MUST PROVIDE ALL NECESSARY SIGNS AND TRAFFIC CONTROL DEVICES TO MOVE TRAFFIC THROUGH OR AROUND THE PROJECT SITE.
- 5. PROVIDE ACCESS FOR EMERGENCY VEHICLES AT ALL TIMES.

# STANDARD SPECIFICATION

PERFORM THE WORK SHOWN BY THESE PLANS IN ACCORDANCE WITH THE ALASKA DEPARTMENT OF TRANSPORTATION AND PUBLIC FACILITIES 2020 STANDARD SPECIFICATIONS FOR HIGHWAY CONSTRUCTION AND THE PROJECT MANUAL.

500 DATE SER!

RECORD OF REVISIONS

DESCRIPTION



DRAWN BY: . ROEMELING DESIGNED BY: ROFMFLING HECKED BY: . CHAMBERS 219 MAIN ST #13 HAINES, AK 99827 2201 DUNN STREET #2 JUNEAU, AK 99801


> solutions@proHNS.cor www.proHNS.com




HAINES BOROUGH VISITOR **CENTER PARKING LOT** 

LEGEND **ABBREVIATIONS GENERAL NOTES**  SHEET NUMBER

OF 6

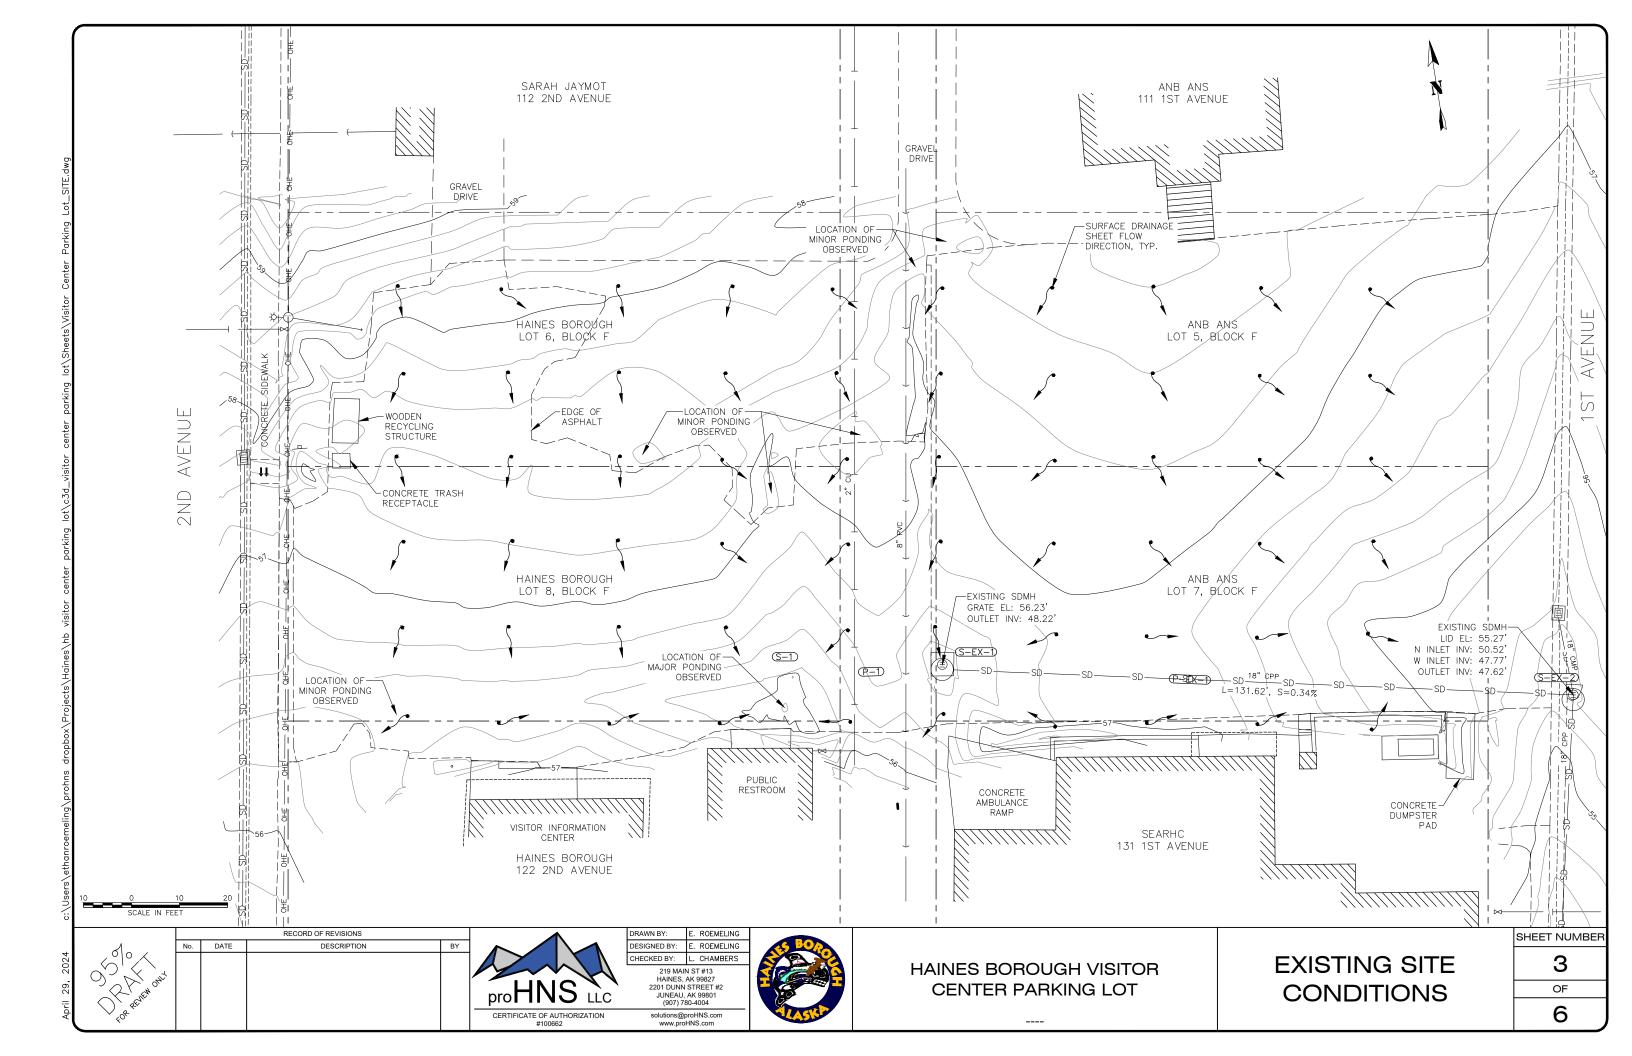


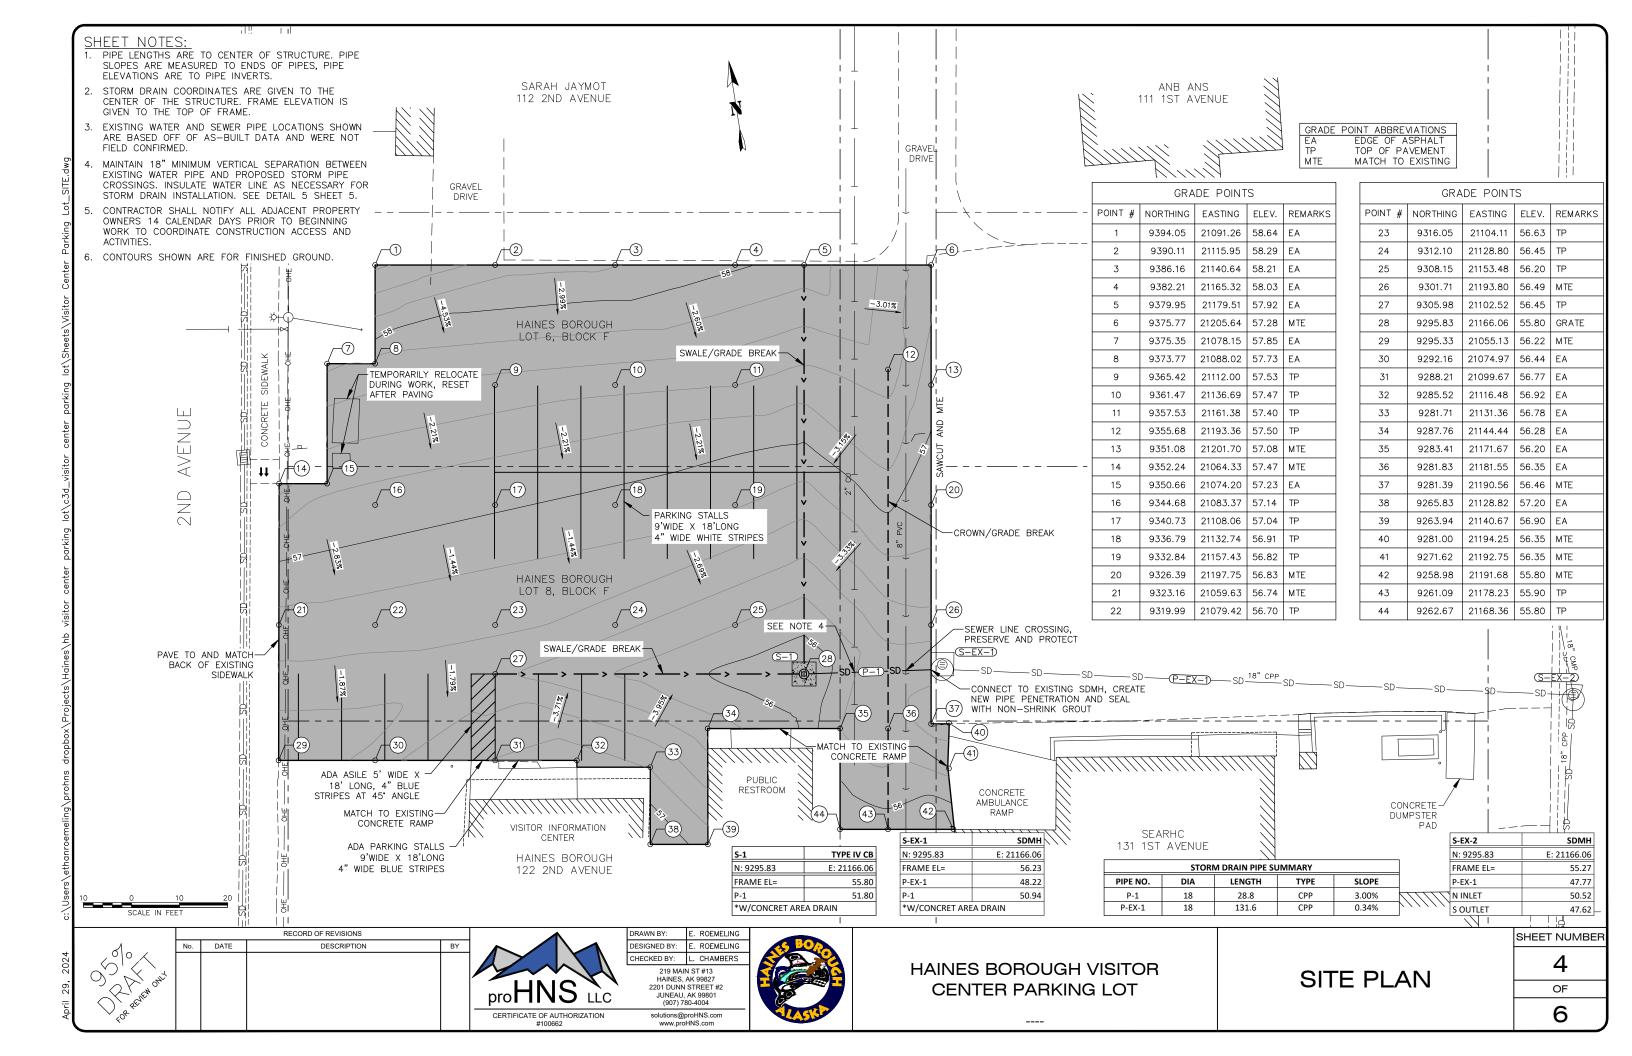




# DETAIL 1/5 NOTES:

- 1. COMPACT D-1 BASE COURSE TO MINIMUM 95% OF MODIFIED PROCTOR DENSITY (ASTM D1557)
- 2. PROOF ROLL BOTTOM OF SUBCUT EXCAVATION SHALL BE PERFORMED USING A MINIMUM 10-TON SELF PROPELLED VIBRATORY COMPACTOR. A MINIMUM OF TWO (2) PASSES (ONE PASS EQUALS DOWN AND BACK) SHALL BE MADE OVER THE SUBCUT SOILS AND AS APPROVED BY THE ENGINEER.

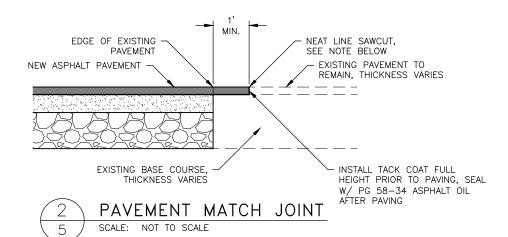


### DETAIL 2/5 NOTES:


1. FINAL SAWCUT OF EXISTING ASPHALT SHALL NOT BE MADE UNTIL 24 HOURS PRIOR TO

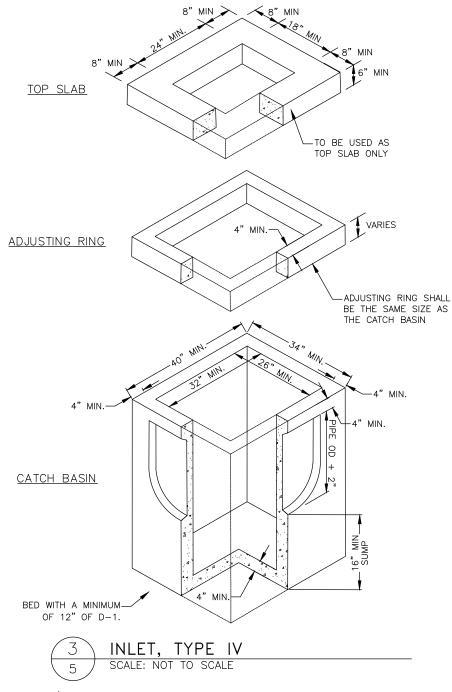


- 1. ENTIRE KNOCKOUT IS TO BE REMOVED AND SEALED SHUT AROUND PIPE. ALL PIPES ARE TO EXTEND MIN. 1" AND MAX. 2" INTO CATCH BASIN.
- THE AREA BETWEEN THE TOP OF THE CATCH BASIN AND THE FRAME SHALL BE FORMED AND FILLED WITH CONCRETE OR NON-SHRINK GROUT. NO BRICKS, WOOD OR OTHER MATERIALS PERMITTED FOR ADJUSTING GRADE.
- FRAME AND GRATE SHALL BE DUCTILE IRON. FRAME MAY BE CAST INTO THE TOP UNIT OR PLACED OVER THE OPENING AS APPROVED BY THE ENGINEER. FRAME AND GRATE MUST BE OF A TYPE THAT WILL NOT CREATE A HAZARD FOR BICYCLE TRAFFIC.
- 4. CATCH BASIN SHALL MEET HIGHWAY STANDARD-20 LOAD REQUIREMENTS
- 5. MINIMUM STEEL REQUIRED AS PER ASTM C-478-69.
- 6. MINIMUM SUMP DEPTH SHALL SHALL BE 16".

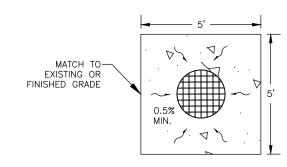

### PLAN VIEW

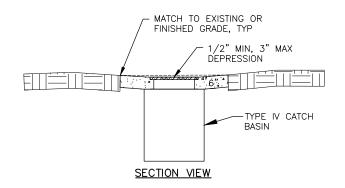

CONCRETE AREA DRAIN DETAIL SCALE: NOT TO SCALE

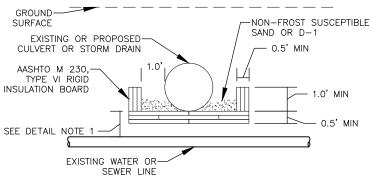

#### UTILITY CROSSING

# WATER LINE INSULATION DETAILS SCALE: NOT TO SCALE

#### DETAIL 5/5 NOTES:

- 1. INSTALL INSULATION AS SHOWN WHEN DISTANCE IS LESS THAN 6.0'.
- 2. PIPE INSULATION SHALL BE 8'-0" IN LENGTH, CENTERED OVER WATER LINE OR WATER SERVICE.
- 3. PIPE INSULATION WITH R-FACTOR EQUAL TO RIGID BOARD MAY BE SUBSTITUTED IF APPROVED BY THE ENGINEER.
- 4. CROSSING SHALL BE PROTECTED WITH A MINIMUM 6" OF INSULATION BOARDS WITH A 12" OVERLAP, AS SHOWN.

RECORD OF REVISIONS DATE DESCRIPTION OSK,



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HAINES BOROUGH VISITOR **CENTER PARKING LOT** 

CONSTRUCTION **DETAILS** 

SHEET NUMBER 5 OF

6