

#### **Haines Borough Planning Commission** May 9, 2024 Regular Meeting **AGENDA**

**Location: Assembly Chambers and on ZOOM** 

#### **Zoom Meeting Information**

Webinar ID: 883 2860 3717 Passcode: 084548

CALL TO ORDER/PLEDGE TO FLAG/LAND ACKNOWLEDGEMENT/ROLL CALL 1.

Brian O'Riley Planning Commissioner

Dan Schultz Planning Commissioner

Derek Poinsette Planning Commissioner

Eben Sargent Planning Commissioner

Erika Merklin Planning Commissioner

Rachel Saitzyk Planning Commissioner

Patty Brown Planning Commissioner

Craig Loomis Assembly Liaison

Annette Kreitzer Borough Manager

Kiersten Long Deputy Clerk

2. **APPROVAL OF AGENDA & CONSENT AGENDA** 

[The following Consent Agenda items are indicated by an asterisk (\*) and will be enacted by the motion to approve the agenda. There will be no separate discussion of these items unless a planning commission member or other person so requests, in which event the asterisk will be removed and that item will be considered by the planning commission on the regular agenda.] Consent Agenda:

3 – Approve Minutes from 4-11-24 Regular Planning Commission

- \*3. APPROVAL OF MINUTES 4-11-24 Regular Planning Commission Meeting
- 4. **PUBLIC COMMENTS** – [For any topics not scheduled for public hearing. Individual comments are limited to 3 minutes unless another yields 3 minutes to the speaker in advance] Note: during this section of the agenda, the commission will listen and take notes. No official action will be taken at this time. Please address the planning commission at the podium provided, use the microphone, and state your full name for the record and the topic of your comment.
- **CHAIR REPORT** 5.
- 6. **COMMISSIONER COMMENTS**
- 7. **SUBCOMMITTEE REPORTS - None**
- 8. **ASSEMBLY LIAISON REPORT - Assembly Member Loomis**
- 9. STAFF REPORT
  - Staff Report Α.
  - **Comprehensive Plan Update** В.
- **PUBLIC HEARINGS None**
- **UNFINISHED BUSINESS None** 11.
- **NEW BUSINESS 12**.

\* Reminder HBC 18.30.040 requires commission review for Borough projects at the conceptual stage of design. At that time, the commission shall decide whether additional design review are required at the 35 percent, 65 percent and 95 percent stages of design.

5<sup>th</sup> to 6<sup>th</sup> Ave Drainage Project 95% Design Α.

At the April 11, 2024 meeting, the 35% design was approved and the commission requested that the plans be brought back at 95%. **Proposed Motion:** Approve 95% Design for the 5<sup>th</sup> to 6<sup>th</sup> Avenue Drainage Project.

Haines Borough Visitor Center Parking Lot 95% Design В. 65% designs were approved at the April 11, 2024 Meeting. **Proposed Motion:** Approve 95% Design for the Haines Borough Visitor Center Parking Lot.

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#### 12. **NEW BUSINESS –** Continued

#### C. Planning Commission Preparation Meeting Calendar

At the April 11, 2024 meeting the Commission decided to recommend to the assembly to change the regular planning commission meeting date in code to the third Thursday of the month. Ordinance 24-04-676 was introduced by the assembly and scheduled for its first public hearing 5/14/24 and a second public hearing 5/28/24. Since the Ordinance is likely to be adopted prior to the next planning commission meeting, the updated prep calendar should be adopted subject to adoption of Ordinance 24-04-676.

**Motion:** Adopt the Updated Planning Commission Preparation Meeting Calendar subject to adoption, by the assembly, of Ordinance 24-04-676.

# D. Capital Improvements Program Review and Recommendation to the Assembly.

Haines Borough Code 3.04.010(E) provides:

E. Prior to adoption of the budget, the planning commission shall review the proposed capital improvements program and submit its recommendations thereon to the borough assembly. The manager shall submit the capital improvements program to the planning commission in a reasonable period in advance of the fiscal year. (See HBC 18.30.040(H).)

#### E. Land Use Permit #24-24 – Joanne Waterman- C-PTC-0B-0100-Significant Structures Zone

The Planning Commission is acting as the Historic District Committee per HBC 18.70.050(C). The commission must first determine if the development is: a) one of the surveyed historic structures, or b) the development has a material effect upon the general character of the district and any of the individual structures. If either of these conditions are met, the commission must apply the 9 specific approval criteria contained in 18.60.020(G).

- 13. PUBLIC COMMENTS
- 14. COMMISSION COMMENTS
- 15. CORRESPONDENCE
- 16. SCHEDULE MEETING DATE

**A.** Set Comprehensive Plan Work Session – May 30 from 5:00-7:00 pm at the Library.

17. ADJOURNMENT

Haines Borough, Alaska Agenda: May 9, 2024

# Haines Borough Planning Commission Meeting April 11, 2024 MINUTES Draft

#### 1. CALL TO ORDER/PLEDGE TO THE FLAG/LAND ACKOWLEDGEMENT/ROLL CALL:

Chair **BROWN** called the meeting to order at 6:39 pm in the assembly chambers and on zoom, and led the pledge to the flag.

Commissioners Present: Patty BROWN, Eben SARGENT, Erika MERKLIN, Dan SCHULTZ,

Derek POINSETTE, Brian O'RILEY

Absent: Rachel SAITZYK

<u>Assembly Members</u>: Craig **LOOMIS**/Liaison,Tom **MORPHET**/Mayor **Staff Present:** Kiersten **LONG**/Deputy Clerk, Tony **WILSON**/It Tech

Visitors Present: Nishan WEERASINGHE, Joe PARNELL, Peter DOHRN, Roger SCHNABEL,

Mathew **JILLSON**, Don **TURNER JR**, and 17 others on zoom.

**2.** <u>APPROVAL OF AGENDA:</u> The following Items were on the published consent agenda indicated by an <u>asterisk</u> (\*)

3 - Approve Minutes from 3-14-24 Regular Planning Commission Meeting

Absent objection hear item 12D and 12E before Item 12A and to remove the minutes from the consent agenda

#### 3. APPROVAL OF MINUTES:

**MOTION MERKLIN** moved to "approve the 3-14-24 minutes" and the motion carried unanimously.

**MOTION**: **SARGENT** moved to "direct the staff to provide the commissioner response forms to be considered in their review of the Conditional Use Permit appeal" and the motion carried unanimously.

#### 4. **PUBLIC COMMENTS**:

**PARNELL** – Derelict buildings in the Fort **TURNER** – Following code Conditional Use Permit

- 5 **CHAIR'S REPORT:** Chair **BROWN** reported on
  - **A.** Geotechnical Conversation
  - **B**. Bear/Human Conflict Taskforce

#### **6. COMMISSIONER COMMENTS:**

SCHULTZ - Making a comment to the Assembly "please use us as a resource"

**POINSETTE** – Bear/Human Conflict Task Force; Bear safety event June 6<sup>th</sup>; Comment deadline has been extended to April 26<sup>th</sup> for the comprehensive plan; Between May 9<sup>th</sup> and June 13<sup>th</sup> will be a planning commission work session; Received email from Constantine North regarding the April 24<sup>th</sup> comment deadline to send a letter to extend the comment deadline to 30 days.

**MOTION: POINSETTE** moved to "send this letter as a body to commissioner John Boyle" and the motion carried unanimously.

**SARGENT** – Planning commission should take their own minutes; Planning Commission should take charge of their own minutes; a list of active topics or projects listed in the minutes that have carried from previous minutes. Thinks things could move through quicker if we are tracking them better; Maybe a spread sheet with a list or somewhere on the agenda.

- 7. **SUBCOMMITTEE REPORTS:** None
- **8. ASSEMBLY LIAISON REPORT:** Assembly member **LOOMIS** reported the assembly passed a motion to rehear cup 23-87 and 23-87B.
- 9. **STAFF REPORT**:
  - A. Staff Report
  - **B.** Comprehensive Plan Update
  - C. Discussion Regarding Planning Commission Meeting Schedule

**MOTION**: **SARGENT** moved to "move Planning Commission Meetings to the third Thursday" and the motion carried unanimously.

#### **10. PUBLIC HEARINGS:**

A. Haines Borough Clean Metal Project Conceptual/35% Designs

The Borough is exploring the creation of a clean metal staging yard to support a junk car and other scrap metal removal project.

Lucas **CHAMBERS**/proHNS was present and available to answer any questions.

The public hearing was opened at 7:46 pm and the following people spoke with respect to this item: **TURNER Jr**. Hearing no further comments, the public hearing was closed at 7:48 pm.

<u>Motion</u>: **SARGENT** moved to "Hold the Haines Borough Clean Meatal Project at 35% to obtain other background history and detailed plans" and the motion carried unanimously.

B. Conditional Use Permit #24-001 Extension of permit #19-03 Resource
Extraction – Highland's Estates Inc. & St. James Place C-208-0400 &
C-208-03A0 – Rural Mixed Use Zone – Continued from the March 11, 2024 Planning
Commission Meeting

The public hearing was opened at 7:52 pm and the following people spoke with respect to this item: **JILLSON**, **TURNER JR.** Hearing no further comments, the public hearing was closed at 7:55 pm.

Roger **SCHNABEL** was present and available to answer questions.

Commissioners discussion of HBC 18.50.040(A) 1-8 Conditional Use Criteria for CUP #24-001

1) The use is so located on the site as to avoid undue noise and other nuisances and dangers;

**Merklin** – Agree

**Poinsette** – Agree

Sargent – Agree

**Schultz**- Agree there hasn't been any comments from the past decades

Brown - Agree

O'RILEY - Agree

2) The development of the use is such that the value of the adjoining property will not be significantly impaired;

**Merklin** – Agrees

**Poinsette** – Agrees, but there has been a comments made

Sargent - Agrees

**Schultz**- Agrees with the borough

**Brown** – Agrees **O'RILEY** - Agrees

<u>Commissioners discussion of HBC 18.50.040(A) 1-8 Conditional Use Criteria for CUP #24-001-Continued:</u>

3) The size and scale of the use is such that existing public services and facilities are adequate to serve the proposed use;

Merklin - Agree the existing public services are adequate

Poinsette – agree Sargent –agree

Schultz- agree

**Brown** – agree

O'RILEY - agree

4) The specific development scheme of the use is consistent and in harmony with the comprehensive plan and surrounding land uses;

**MERKLIN** – yes; it is a neighborhood can see a change in the future; the neighborhood is changing but as it is now I agree

**POINSETTE** – yes but acknowledging it might change in the future

**SARGENT** – Current uses should focus on comprehensive plan in effect right now agrees

**SCHULTZ** - yes, it is shown to be consistent for decades

**BROWN** – Agree based on current comprehensive plan

O'RILEY – agree, but we have to look to the future and keep options open

5) The granting of the conditional use will not be harmful to the public safety, health, or welfare;

Merklin – agree

Poinsette - yes; we do have another geological technical document coming out in the future

**Sargent** – agree, doesn't think the proposed development plan looking at the site, slope, and material would be consistent on what has been taken out won't substancally change the landslide considerations or trigger any other additional public safety impacts

Schultz- agree Brown – agree O'RILEY - agree

6) The use will not significantly cause erosion, ground or surface water contamination or significant adverse alteration of fish habitat on any parcel adjacent to state-identified anadromous streams;

Merklin – agree Poinsette – yes Sargent – agree Schultz - agree

**Brown** – agree

O'RILEY - agree

7) The use will comply with all required conditions and specifications if located where proposed and developed, and operated according to the plan as submitted and approved;

Merklin - agree

**Poinsette** – agree

Sargent - agree

Schultz- agree

Brown - agree

O'RILEY - agree

<u>Commissioners discussion of HBC 18.50.040(A) 1-8 Conditional Use Criteria for CUP #24-001-Continued:</u>

# 8) Comments received from property owners impacted by the proposed development have been considered and given their due weight;

Merklin -agree
Poinsette - agree
Sargent - agree
Schultz- agree
Brown - agree
O'RILEY - agree

<u>Commissioners discussed HBC 18.60.010 A-U General Approval Criteria for CUP #24-001</u>

After consideration, there was unanimous agreement with the manager's recommendations for the general approval criteria for CUP #24-001.

**MOTION: SARGENT** moved to "approve Conditional Use Permit #24-001 with the manager's conditions and a life span of five years" and the motion carried 5-1 with **BROWN** opposed.

#### 11. **UNFINISHED BUSINESS:** None

#### 12. NEW BUSINESS:

\*\*Clerk's Note: Item 12D the 12E were heard at this point in the meeting.

#### A. 5<sup>th</sup> to 6<sup>th</sup> Ave Drainage Project 35% Design

Ethan **ROEMELING**/proHNS was present to speak regarding this item.

**MOTION: SARGENT** moved to "approve 35% designs and bring it back at 95%" and the motion carried unanimously.

#### B. Haines Borough Visitor Center Parking Lot 65% Design

Ethan **ROEMELING**/proHNS was present to speak regarding this item.

**MOTION: POINSETTE** moved to "approve 65% designs and bring it back at 95%" and the motion carried unanimously.

#### C. Piedad, Library, and Admin Generator Project 65% Design

Benjamin **HAIGHT/**RESPEC presenting regarding this item.

**MOTION: POINSETTE** moved to "approve 65% designs and bring it back at 95%" and the motion carried unanimously.

#### D. Request for Planning Commission Action - Peter Dohrn

The Planning Commission had a discussion with Mr. DOHRN with respect to the Mathias Ave Project. The following members of the public also spoke reagarding this item: **TURNER JR.** 

# E. <u>Land Use Permit # 24-012 - June Haas & Kay Dunning - C-PTC-0I-0200 - Significant Structures Area Zone</u>

<u>MOTION</u>: **SARGENT** moved to "approve LUP 24-012 since the commission found that the development is not one of the surveyed structures and it doesn't have a material effect upon the character of the district" and the motion carried unanimously.

13. **PUBLIC COMMENTS:** None

#### 14. ANNOUNCEMENTS / COMMISSION COMMENTS:

**SCHULTZ** – Adjusting starting time to 6:00 pm

**SARGENT –** State Road Project

**BROWN** – Lutak Dock

**15. CORRESPONDENCE:** None

#### **16. SET MEETING DATE:**

A. Set Comprehensive Plan Work Session – Thursday, June 6, 2024 at 6:30 pm Assembly Chambers

17. ADJOURNMENT: 9:34pm


ATTEST:	Planning Commission Chair
Kiersten Long, Borough Deputy Clerk	

Highlands Estates   03A0		PERMIT	
### APPROVED   24-001   Highlands Estates   03A0   03A0			PRIMARY LAND USE
Highlands Estates		1	
PENDING   24-003   Studley   VARIOUS	-TL- RMU	CUP	Resource Extraction/ Proc.
PENDING         24-004         HFR         C-735-03-0600           APPROVED         24-005         Clark         4-MBR-07-1210           APPROVED         24-006         Joiner         C-NUK-00-0600/07A3           PENDING         24-007         Ordonez         C-SKY-0A-0600           PENDING         24-008         PRIOR/MOORE         C-MEA-02-2700           APPROVED         24-009         DON BOYD         C-ANY-11-0100           PENDING         24-010         Nickolas Scholsstein         C-ANY-06-0200/0300           PENDING         24-011         4-MBR-07-1210           APPROVED         24-012         June Haas/Kay Dunning         C-PTC-0I-0200           PENDING         24-013         Chisel Ent. Ira Henry         C-785-00-0700           PENDING-PC         24-014         Frank Berlogar         C-HHY-01-002A           APPROVED         24-017         James Alborough         C-KLO-11-0200           APPROVED         24-018         Stephanie Anderson         C-NUK-00-0900           APPROVED         24-019         Stephanie Anderson         C-NUK-00-0900           APPROVED         24-020         Haines Industrial         C-PTC-07-1000           PENDING         24-021         Paul Gaither         C-	I/L/C	LUP	Marijuana, Retail
Part		ROWU	
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Haines Industrial   C-PTC-07-1000	SR	ROWD	Single Unit Dwelling
PENDING         24-022         Harry Rietze         C-735-03-0600           PENDING         24-023         Delta Western         C-MIS-0A-0100           PENDING-PC         24-024         Joanne Waterman         C-PTC-0B-0100	С	SD	Site Development
PENDING 24-023 Delta Western C-MIS-0A-0100 PENDING-PC 24-024 Joanne Waterman C-PTC-0B-0100	SR	LUP	Single Unit Dwelling
PENDING-PC 24-024 Joanne Waterman C-PTC-0B-0100	I/L/C	SD	
	С	SD	Site Development
	SSA	LUP	Accessory Uses
PENDING 24-025 Stephanie Anderson C-NUK-00-0900		W/S	

# 5TH TO 6TH AVENUE DRAINAGE IMPROVEMENTS

SHEET INDEX SHEET NO. DESCRIPTION COVER SHEET LEGEND ABBREVIATIONS GENERAL NOTES EXISTING SITE CONDITIONS & DRAINAGE PATTERNS CONSTRUCTION DETAILS SURVEY CONTROL SHEET

HAINES BOROUGH, ALASKA

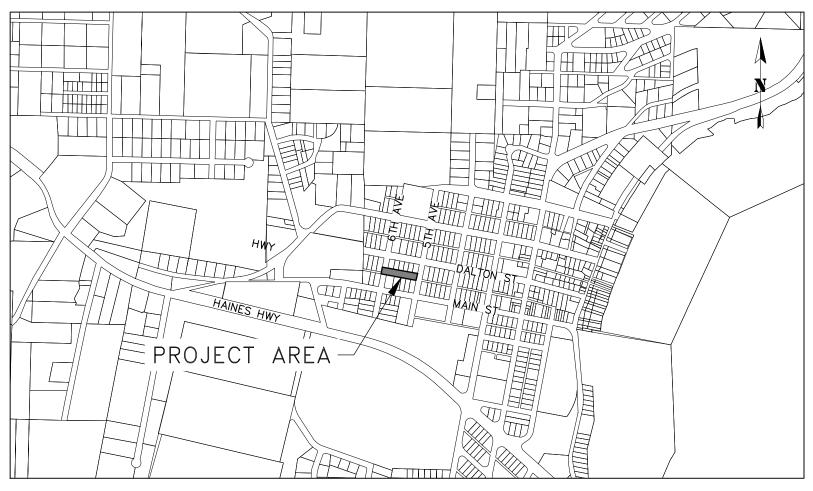

PROJECT LOCATION MAP NTS



RECORD OF REVISIONS

CERTIFICATE OF AUTHORIZATION

E. ROEMELING DESIGNED BY: E. ROEMELING 2201 DUNN STREET #2 JUNEAU, AK 99801 (907) 780-4004

solutions@proHNS.com www.proHNS.com



**5TH TO 6TH AVENUE** DRAINAGE IMPROVEMENTS

**COVER SHEET** 

**VICINITY MAP** 

NTS

SHEET NUMBER OF

#### ABBREVIATIONS

ASPHALT CONCRETE BOP BEGINNING OF PROJECT ВТМ ВОТТОМ BEGIN VERTICAL CURVE CB CATCH BASIN CENTERLINE CORRUGATED METAL PIPE CMP CORRUGATED POLYETHYENE PIPE CPP CONCRETE CONC CTE CONNECT TO EXISTING DUCTILE IRON PIPE DIA DIAMETER FIFVATION END OF PROJECT EOP **EXISTING** EX FINISHED GRADE FG FIRE HYDRANT GATE VALVE HAINES BOROUGH HIGH DENSITY POLYETHYLENE HDPE INVERT ELEVATION INVERT INV LVC LENGTH OF VERTICAL CURVE MANHOLE MIN MINIMUM MATCH TO EXISTING MTE NOT IN CONTRACT NIC NO NUMBER NOT TO SCALE NTS OD OUTSIDE DIAMETER OVERHEAD ELECTRIC POINT OF CURVATURE POUNDS PER SQUARE INCH PSI POINT OF TANGENT POLYVINYL CHLORIDE PIPE PVC POINT OF VERTICAL INTERSECTION RADIUS POINT RT RIGHT RIGHT-OF-WAY ROW STORM DRAIN MANHOLE SDMH SANITARY SEWER MANHOLE SSMH STA STATION STANDARD TOP BACK OF CURB TOP BACK OF GUTTER TRG TEMPORARY BENCHMARK TRM TOP OF PAVEMENT TYPICAL VERTICAL POINT OF CURVATURE VPC VERTICAL POINT OF INTERSECTION VERTICAL POINT OF TANGENCY

#### GENERAL NOTES

- 1. ALL WORK FOR THESE PLANS SHALL BE CONDUCTED IN STRICT ACCORDANCE WITH ALL APPLICABLE LOCAL, STATE AND FEDERAL LAWS AND STANDARDS.
- 2. LOCATIONS AND ELEVATION OF EXISTING UNDERGROUND WATER, SEWER, POWER, TELEPHONE AND CABLE TELEVISION SHOWN ON THE PLANS WERE DERIVED FROM HAINES BOROUGH AS—BUILTS AND FIELD LOCATES. THE ACTUAL LOCATION OF UTILITIES MAY VARY FROM THOSE SHOWN. THE CONTRACTOR IS RESPONSIBLE FOR LOCATING, PROTECTING AND MAINTAINING EXISTING UTILITIES THROUGHOUT THE CONSTRUCTION OF THE PROJECT. ANY DAMAGE TO UTILITIES DURING CONSTRUCTION SHALL BE PAID FOR BY THE CONTRACTOR AND SHALL BE CONSIDERED INCIDENTAL TO THE CONTRACT. THE CONTRACTOR SHALL CONTACT AND REQUEST UTILITY LOCATES, AT A MINIMUM, FROM THE FOLLOWING PRIOR TO BEGINNING EARTH DISTURBING ACTIVITIES:
  - A) HAINES BOROUGH PUBLIC FACILITIES, 907-766-6414.
  - B) ALASKA POWER & TELEPHONE(AP&T), 907-766-6500.
  - C) HAINES CABLE TV, 907-766-2337.
- 3. A GEOTECHNICAL INVESTIGATION WAS NOT PERFORMED AS PART OF THIS DESIGN. HARDPAN, CLAY, GROUNDWATER, LARGE BOULDERS, BEDROCK, STUMPS, LOGS, ORGANICS, AND OTHER NATIVE MATERIALS MAY BE ENCOUNTERED AT VARIOUS DEPTHS DURING TRENCHING AND SITE GRADING OPERATIONS.
- 4. THE TOTAL DISTURBED AREA FOR THIS PROJECT IS ANTICIPATED TO BE LESS THAN ONE ACRE.
- 5. ALL DISTURBED AREAS SHALL BE RESTORED TO EXISTING CONDITIONS AND GRADES, AND STABILIZED WITH AN APPROVED HYDRAULIC GROWTH MEDIUM AND GRASS SEED UNLESS OTHERWISE SHOWN ON THE PLANS.
- 6. CONTRACTOR SHALL ENSURE GARBAGE PICKUP, PRIVATE AND BUSINESS DELIVERIES, AND DAILY MAIL SERVICE WILL BE UNINTERRUPTED TO ALL BUSINESS AND RESIDENCES AFFECTED BY THIS PROJECT.
- 7. THE CONTRACTOR SHALL NOTIFY EACH PROPERTY OWNER OF DRIVEWAY CLOSURE 48 HOURS PRECEDING THE DAY THE DRIVEWAY IS TO BE CLOSED TO VEHICULAR ACCESS. THE PROPERTY OWNER SHALL BE INFORMED OF THE PERIOD OF TIME THE CLOSURE WILL BE IN EFFECT. NO DRIVEWAY CLOSURES WILL BE PERMITTED UNTIL THIS REQUIREMENT HAS BEEN MET TO THE SATISFACTION OF THE ENGINEER.
- 8. THE CONTRACTOR SHALL NOT STORE MATERIALS OR EQUIPMENT, OR OPERATE EQUIPMENT WITH ITS TRACKS OR WHEELS PLACED ON PRIVATE PROPERTY, WITHOUT THE APPROVAL OF THE PROPERTY OWNER.
- 9. THE PLAN DRAWINGS DO NOT SHOW ALL PLANTINGS, AND OTHER LANDSCAPING THAT WILL BE ENCOUNTERED DURING CONSTRUCTION ACTIVITIES. NO PLANTINGS OR LANDSCAPING ARE TO BE REMOVED OR DAMAGED, UNLESS SHOWN ON THE DRAWINGS OR DIRECTED BY THE ENGINEER.
- 10. ALL ITEMS DESIGNATED TO BE REMOVED SHALL BE DISPOSED OF OFF-SITE, EXCEPT AS NOTED IN THE CONTRACT DOCUMENTS. ALL OTHER MATERIALS TO BE REMOVED AND DISPOSED OF SHALL BECOME THE PROPERTY OF THE CONTRACTOR, INCLUDING CONCRETE, ASPHALT, UNSUITABLE SOILS AND ETC.
- 11. WORK SHALL BE PERFORMED MONDAY THROUGH FRIDAY, 8AM TO 5PM ONLY.

#### TRAFFIC CONTROL NOTES

- 1. ALL TRAFFIC TO BE CONTROLLED PER REQUIREMENTS OF THE ALASKA TRAFFIC MANUAL, U.S. DEPARTMENT OF TRANSPORTATION "MANUAL ON UNIFORM TRAFFIC CONTROL DEVICES" AND THE ALASKA SUPPLEMENT.
- 2. MAINTAIN ONE (1) LANE FOR TRAFFIC AT ALL TIMES UNLESS OTHERWISE APPROVED BY THE ENGINEER.
- 3. NOTIFICATION OF WORK THAT MAY IMPEDE TRAFFIC MUST BE PROVIDED TO THE HB PUBLIC WORKS DEPARTMENT, HB POLICE DEPARTMENT, HAINES VOLUNTEER FIRE DEPARTMENT, CHILKOOT INDIAN ASSOCIATION, ALASKA DOT&PF HAINES M&O FOREMAN, AND THE GENERAL PUBLIC A MINIMUM OF 72 HOURS IN ADVANCE OF IMPLEMENTING TRAFFIC CONTROL.
- 4. CONTRACTOR MUST PROVIDE ALL NECESSARY SIGNS AND TRAFFIC CONTROL DEVICES TO MOVE TRAFFIC THROUGH OR AROUND THE PROJECT SITE.
- 5. PROVIDE ACCESS FOR EMERGENCY VEHICLES AT ALL TIMES.

## STANDARD SPECIFICATION

PERFORM THE WORK SHOWN BY THESE PLANS IN ACCORDANCE WITH THE ALASKA DEPARTMENT OF TRANSPORTATION AND PUBLIC FACILITIES 2020 STANDARD SPECIFICATIONS FOR HIGHWAY CONSTRUCTION AND THE PROJECT MANUAL.

No. DATE DESCRIPTION

RECORD OF REVISIONS

DESCRIPTION



DRAWN BY: E. ROEMELING
DESIGNED BY: E. ROEMELING
CHECKED BY: L. CHAMBERS

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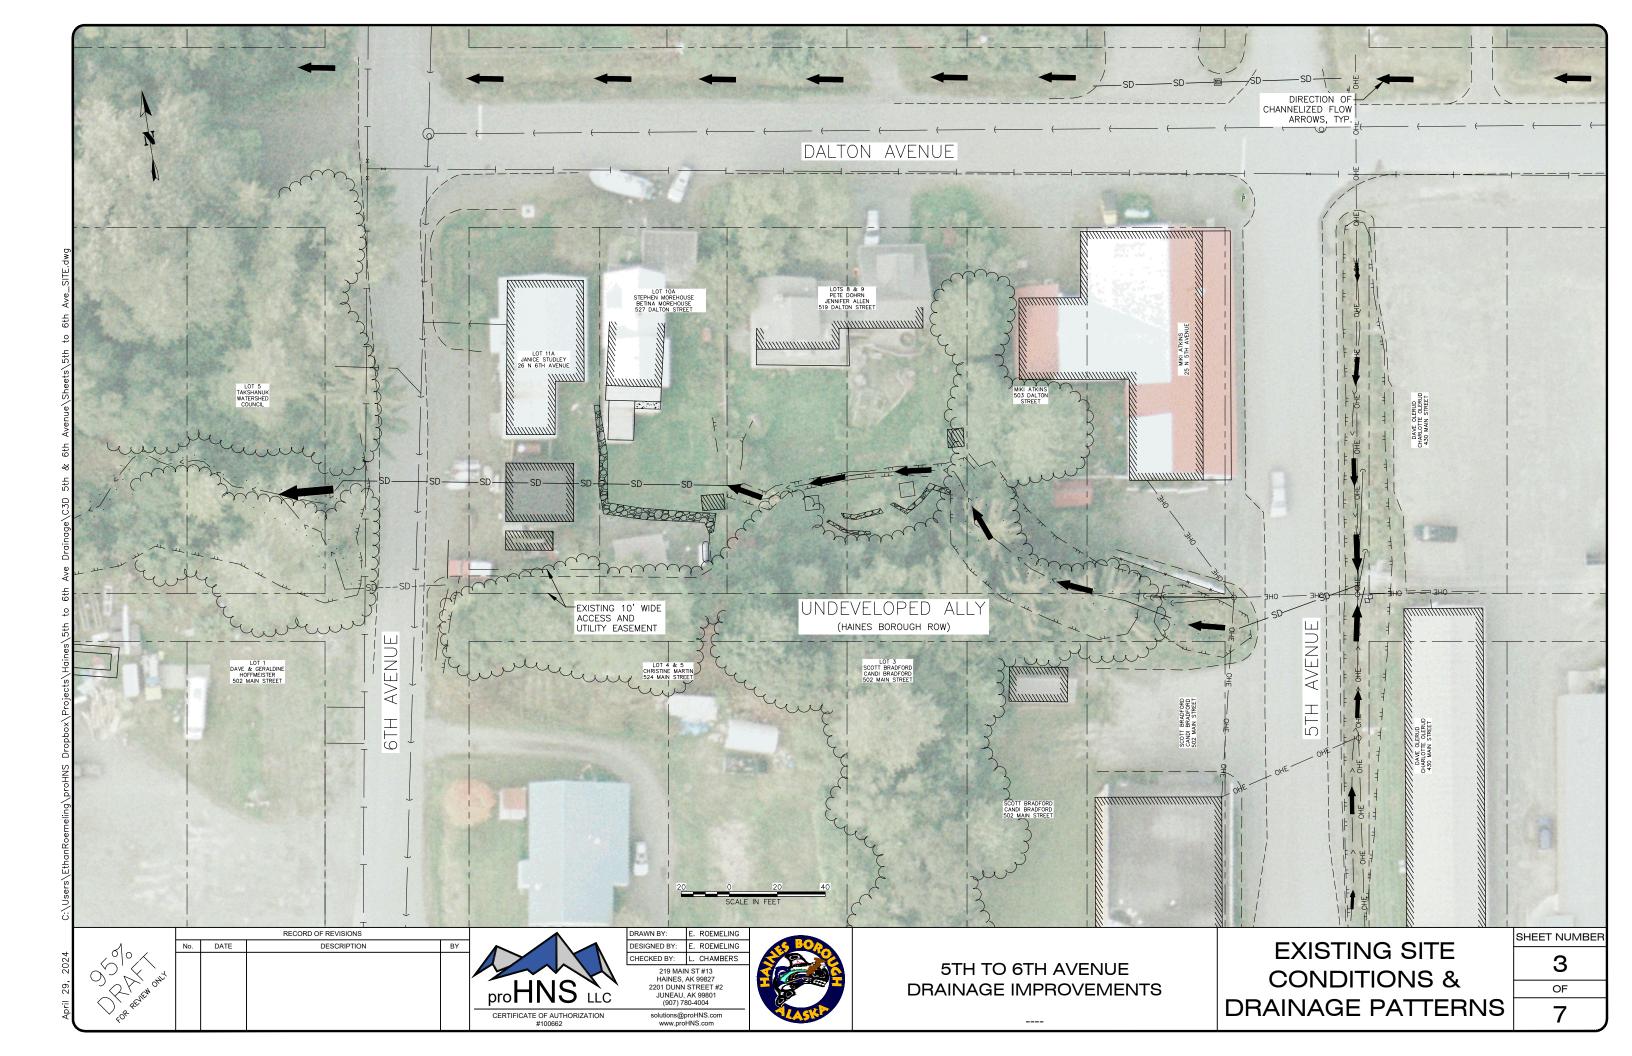



5TH TO 6TH AVENUE DRAINAGE IMPROVEMENTS

LEGEND ABBREVIATIONS GENERAL NOTES SHEET NUMBER

OF

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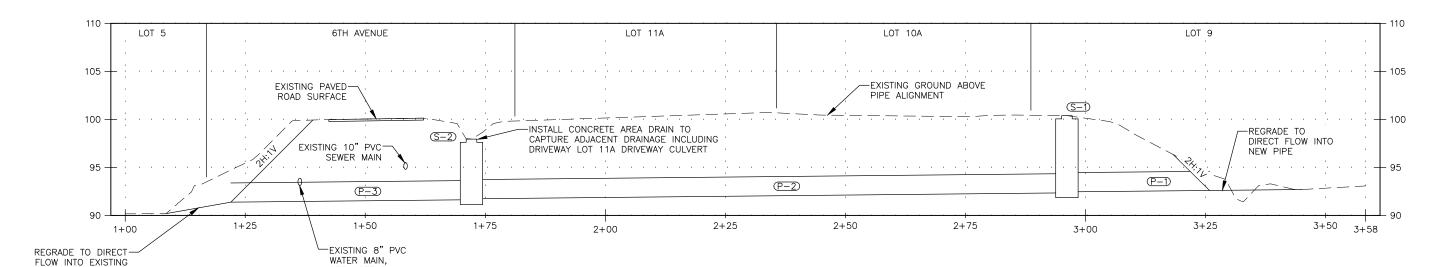


S-2	TYPE I SDMH				
N: 10242.51	E: 19680.34				
FRAME EL=	97.95				
P-2	91.73				
P-3 91.6					
*W/CONCRET AREA DRAIN					

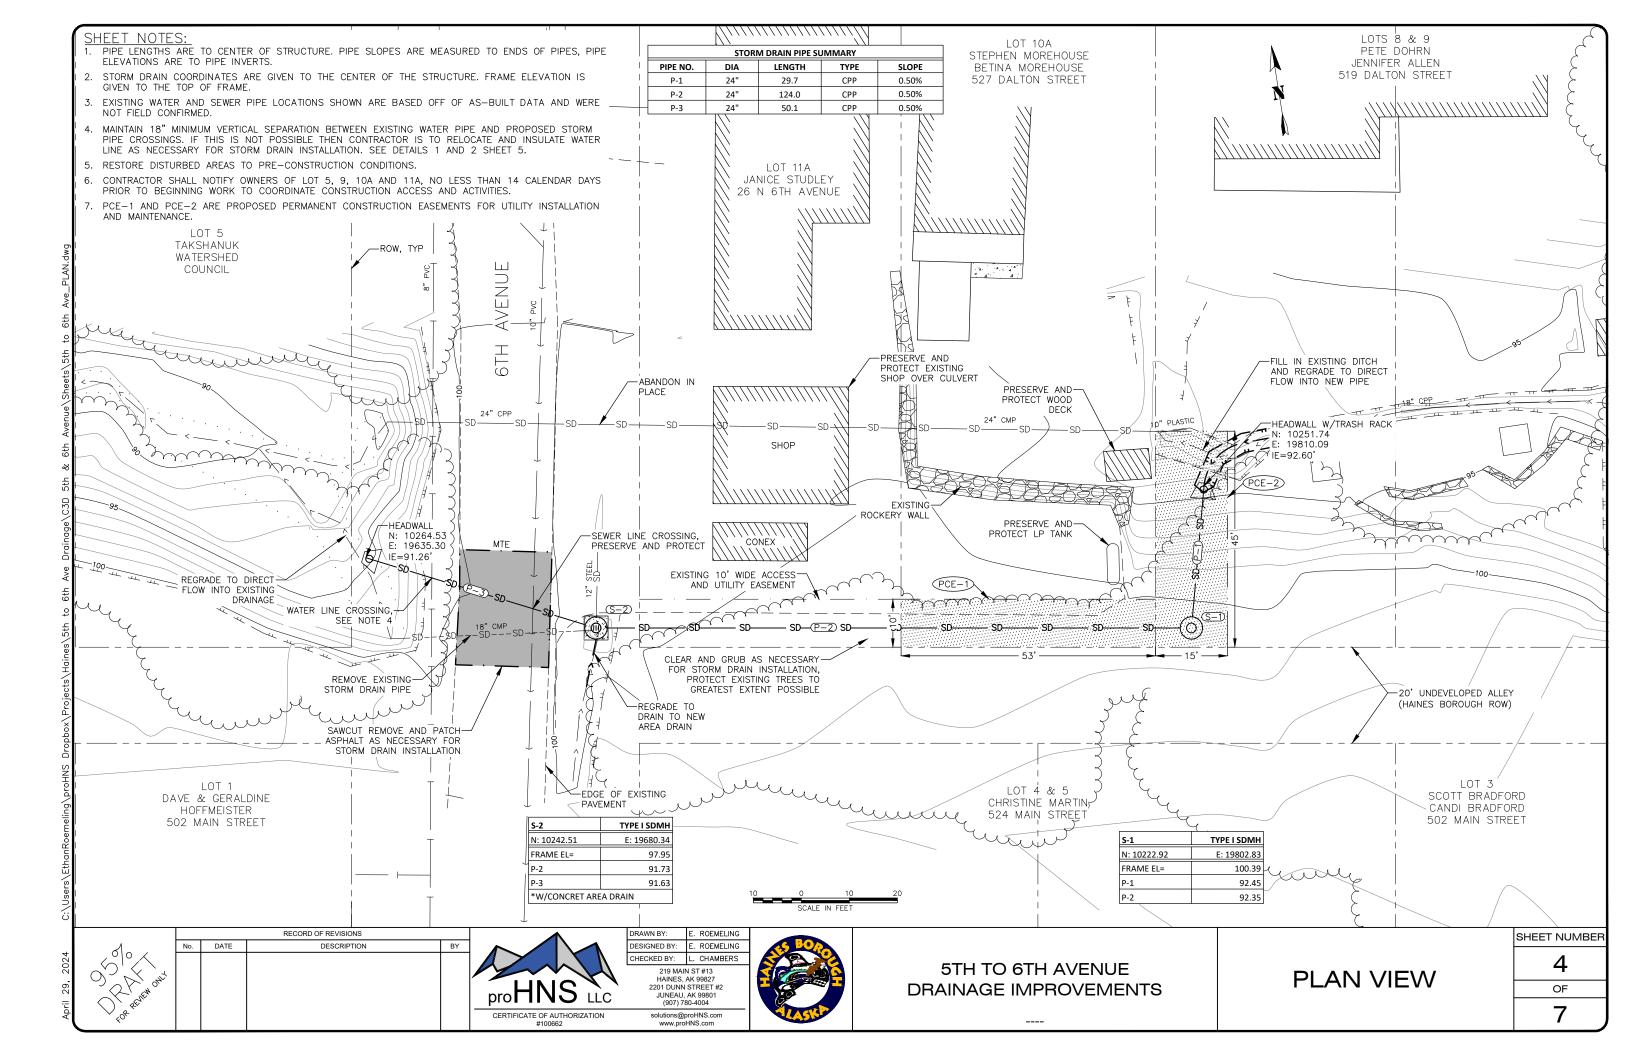SEE NOTE 5

STORM DRAIN PIPE SUMMARY					
PIPE NO.	DIA	LENGTH	TYPE	SLOPE	
P-1	24"	29.7	CPP	0.50%	
P-2	24"	124.0	CPP	0.50%	
P-3	24"	50.1	CPP	0.50%	

S-1	TYPE I SDMH
N: 10222.92	E: 19802.83
FRAME EL=	100.39
P-1	92.45
P-2	92.35



#### PIPE NETWORK PROFILE

#### SHEET NOTES:


- 1. PROFILE FOLLOWS THE ALIGNMENT OF THE PIPE AND DRAINAGE, SEE PLAN VIEW FOR HORIZONTAL LAYOUT.
- 2. PIPE LENGTHS ARE TO CENTER OF STRUCTURE. PIPE SLOPES ARE MEASURED TO ENDS OF PIPES, PIPE ELEVATIONS ARE TO PIPE INVERTS.
- 3. STORM DRAIN COORDINATES ARE GIVEN TO THE CENTER OF THE STRUCTURE. FRAME ELEVATION IS GIVEN TO THE TOP OF FRAME.
- 4. EXISTING WATER AND SEWER PIPE ELEVATIONS SHOWN IN PROFILE VIEW ARE BASED OFF OF AS-BUILT DATA AND WERE NOT FIELD CONFIRMED.
- 5. MAINTAIN 18" MINIMUM VERTICAL SEPARATION BETWEEN EXISTING WATER PIPE AND PROPOSED STORM PIPE CROSSINGS. IF THIS IS NOT POSSIBLE THEN CONTRACTOR IS TO RELOCATE AND INSULATE WATER LINE AS NECESSARY FOR STORM DRAIN INSTALLATION. SEE DETAILS 1 AND 2 THIS SHEET.
- 6. RESTORE DISTURBED AREAS TO PRE-CONSTRUCTION CONDITIONS.
- 7. CONTRACTOR SHALL NOTIFY OWNERS OF LOT 5, 9, 10A AND 11A, NO LESS THAN 14 CALENDAR DAYS PRIOR TO BEGINNING WORK TO COORDINATE CONSTRUCTION ACCESS AND ACTIVITIES.

# -REMOVE EX WATERLINE, AS NEEDED -EX 8" PVC DRAIN PIPE WATERLINE 1/2 PIPE DIAMETER (OR 12" MIN) 18" MIN 6" RIGID BOARD INSULATION WATERLINE 45° PVC RESTRAINED – FITTING (TYP)

VERTICAL WATERLINE RELOCATION SCALE: NOT TO SCALE

DETAIL 2/5 NOTES:


1. SEE DETAIL 1 THIS SHEET.

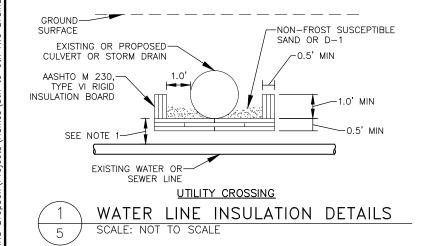

DRAINAGE

#### DETAIL 1/5 NOTES:

- 1. INSTALL INSULATION AS SHOWN WHEN DISTANCE IS LESS THAN 6.0'.
- 2. PIPE INSULATION SHALL BE 8'-0" IN LENGTH, CENTERED OVER WATER LINE OR WATER
- 3. PIPE INSULATION WITH R-FACTOR EQUAL TO RIGID BOARD MAY BE SUBSTITUTED IF APPROVED BY THE ENGINEER.
- 4. CROSSING SHALL BE PROTECTED WITH A MINIMUM 6" OF INSULATION BOARDS WITH A 12" OVERLAP, AS SHOWN.

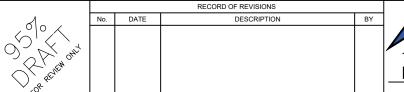






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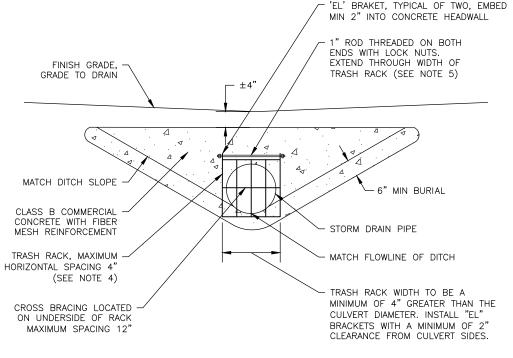
5TH TO 6TH AVENUE DRAINAGE IMPROVEMENTS

**PROFILE VIEW** 

SHEET NUMBER 5 OF



- A TYPE THAT WILL NOT CREATE A HAZARD FOR BICYCLE TRAFFIC.
- 5. MANHOLE SHALL MEET HIGHWAY STANDARD-20 LOAD REQUIREMENTS.
- 6. MINIMUM STEEL REQUIRED AS PER ASTM C-478-69
- 7. MINIMUM SUMP DEPTH SHALL SHALL BE 16".

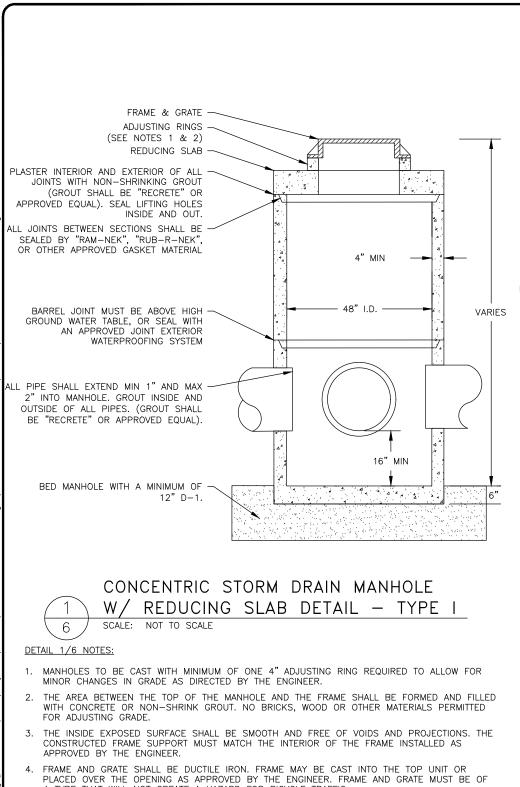

CLASS B COMMERCIAL CONCRETE

WITH FIBER MESH REINFORCEMENT

3/4" SPACER TAB TO KEEP

RACK OFF CONCRETE

TRASH RACK SHALL SWING OPEN, PROVIDE

3/4" SPACE BETWEEN RACK AND CONCRETE.

OF HEADWALL. (SEE NOTE 5)


MITER CULVERT TO MATCH SLOPE

DITCH LINE GRADE TO

MATCH FLOWLINE OF PIPE

FINISH GRADE,


GRADE TO DRAIN

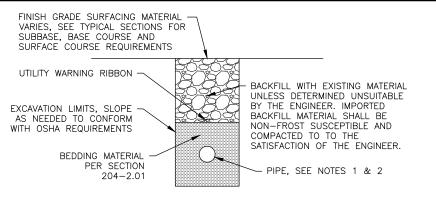

PIPE TRENCH DETAIL SCALE: NOT TO SCALE

#### DETAIL 3/6 NOTES:

- 1. FOR PIPE SIZE AND MATERIAL SEE CONSTRUCTION PLAN,
- 2. PIPE TO HAVE MINIMUM 1' BEDDING IN EACH DIRECTION.

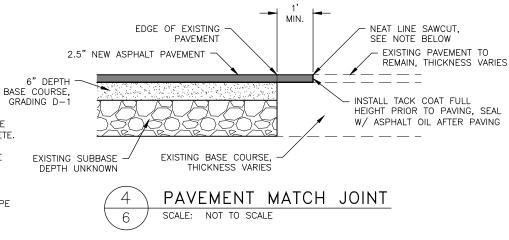


#### DETAIL 4/6 NOTES:

MATCH TO-

EXISTING OR

FINISHED GRADE

FINAL SAWCUT OF EXISTING ASPHALT SHALL NOT BE MADE UNTIL 24 HOURS PRIOR TO PAVING

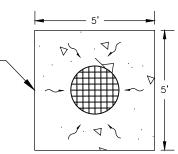

PLAN VIEW

MATCH TO EXISTING OR FINISHED GRADE, TYP /2" MIN 3" MAX DEPRESSION -TYPE IV CATCH BASIN SECTION VIEW

CONCRETE AREA DRAIN DETAIL SCALE: NOT TO SCALE


#### DETAIL 2/6 NOTES:

6

- 1. SLOPE OF HEADWALL SHALL BE 1:1 OR FLATTER AND SHALL BE DETERMINED MY THE ENGINEER.
- 2. IF CORRUGATED PLASTIC PIPE IS USED, EMPTY WATER FROM CORRUGATIONS ON MITERED ENDS AND THEN COMPLETELY FILL VOIDS WITH CONCRETE GROUT

STANDARD CONCRETE HEADWALL DETAIL

- 3. NO HEADWALLS ARE TO BE CONSTRUCTED WITHIN DOT&PF RIGHT-OF-WAY UNLESS DIRECTED BY THE ENGINEER.
- 4. TRASH RACKS SHALL BE REQUIRED ON HEADWALLS AT UPSTREAM ENDS OF CULVERTS NETERING CLOSED STORM DRAIN SYSTEMS, TRASH RACK BARS TO BE CONSTRUCTED OF 2" X 3/8" BARS, HEADWALLS THAT REQUIRE TRASH RACKS ARE IDENTIFIED ON THE PLAN SHEETS.
- 5. ALL COMPONENTS OF THE TRASH RACK SHALL BE CONSTRUCTED OF EITHER 6061 ALUMINUM OR HOT DIPPED GALVANIZED STEEL.

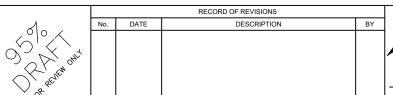





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6" MIN

STORM DRAIN PIPE

(SEE NOTE 1)

SCALE: NOT TO SCALE

SLOPE OF HEADWALL

CROSS BRACING LOCATED

ON UNDERSIDE OF RACK



CONSTRUCTION **DETAILS** 

SHEET NUMBER 6 OF

# HAINES BOROUGH VISITOR CENTER PARKING LOT

SHEET NO.

SHEET NO.

DESCRIPTION

1 COVER SHEET

2 LEGEND ABBREVIATIONS GENERAL NOTES


3 EXISTING SITE CONDITIONS

4 SITE PLAN

5 CONSTRUCTION DETAILS

6 SURVEY CONTROL SHEET

HAINES BOROUGH, ALASKA

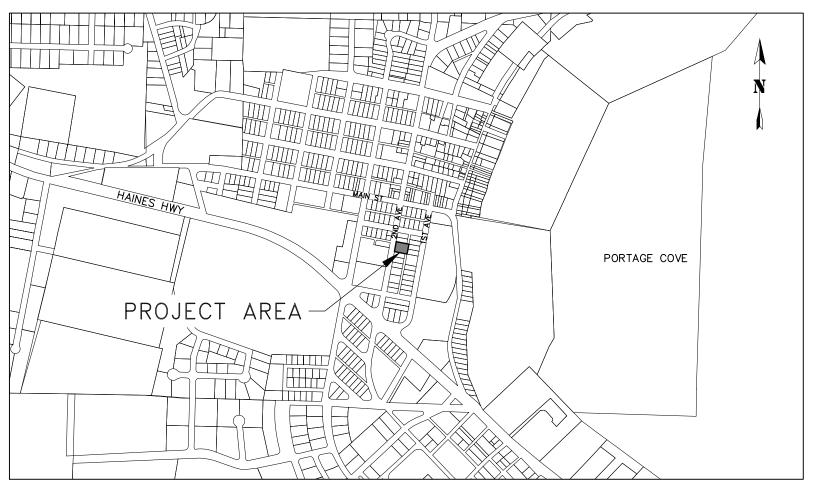

BERING SEA

BETHEL

BETHEL

ANCHORAGE

HAINES

SITKA

SITKA

ALASKA

ALASKA

PROJECT LOCATION MAP

VICINITY MAP

RECORD OF REVISIONS

No. DATE DESCRIPTION BY

OR RELIEF NOTE: The second of the second

pro HNS LLC

CERTIFICATE OF AUTHORIZATION

DRAWN BY: E. ROEMELING
DESIGNED BY: E. ROEMELING
CHECKED BY: L. CHAMBERS
219 MAIN ST #13
HAINES, AK 99827
2201 DUNN STREET #2
JUNEAU, AK 99801
(907) 780-4004



HAINES BOROUGH VISITOR CENTER PARKING LOT

**COVER SHEET** 

SHEET NUMBER

1

OF

6

April 29, 2024

\_EGEND

#### ABBREVIATIONS

AC BOP ASPHALT CONCRETE BEGINNING OF PROJECT BTM CB CATCH BASIN CENTERLINE CMP CORRUGATED METAL PIPE CORRUGATED POLYETHYENE PIPE CPP CONC CTE CONCRETE CONNECT TO EXISTING DIP DUCTILE IRON PIPE DIA DIAMETER FDGE OF ASPHALT **FI EVATION** END OF PROJECT FOF **EXISTING** FG FINISHED GRADE FIRE HYDRANT GATE VALVE HAINES BOROUGH HIGH DENSITY POLYETHYLENE HDPE INVERT ELEVATION INV LENGTH OF VERTICAL CURVE LVC MANHOLE MINIMUM MIN MATCH TO EXISTING MTE NIC NOT IN CONTRACT NO NUMBER NTS NOT TO SCALE OD OUTSIDE DIAMETER OHE PSI PVI OVERHEAD FLECTRIC POUNDS PER SQUARE INCH POLYVINYL CHLORIDE PIPE RP RADIUS POINT RIGHT RIGHT-OF-WAY STORM DRAIN MANHOLF SDMH SSMH STA SANITARY SEWER MANHOLE STATION STANDARD STD TBC TOP BACK OF CURB TOP BACK OF GUTTER TEMPORARY BENCHMARK TP TOP OF PAVEMENT TYP **TYPICAL** 

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- 7. THE CONTRACTOR SHALL NOTIFY EACH PROPERTY OWNER OF DRIVEWAY CLOSURE 48 HOURS PRECEDING THE DAY THE DRIVEWAY IS TO BE CLOSED TO VEHICULAR ACCESS. THE PROPERTY OWNER SHALL BE INFORMED OF THE PERIOD OF TIME THE CLOSURE WILL BE IN EFFECT. NO DRIVEWAY CLOSURES WILL BE PERMITTED UNTIL THIS REQUIREMENT HAS BEEN MET TO THE SATISFACTION OF THE ENGINEER
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- NOTIFICATION OF WORK THAT MAY IMPEDE TRAFFIC MUST BE PROVIDED TO THE HB PUBLIC WORKS DEPARTMENT, HB POLICE DEPARTMENT, HAINES VOLUNTEER FIRE DEPARTMENT, CHILKOOT INDIAN ASSOCIATION, ALASKA DOT&PF HAINES M&O FOREMAN, AND THE GENERAL PUBLIC A MINIMUM OF 72 HOURS IN ADVANCE OF IMPLEMENTING TRAFFIC CONTROL.
- 4. CONTRACTOR MUST PROVIDE ALL NECESSARY SIGNS AND TRAFFIC CONTROL DEVICES TO MOVE TRAFFIC THROUGH OR AROUND THE PROJECT SITE.
- 5. PROVIDE ACCESS FOR EMERGENCY VEHICLES AT ALL TIMES.

## STANDARD SPECIFICATION

PERFORM THE WORK SHOWN BY THESE PLANS IN ACCORDANCE WITH THE ALASKA DEPARTMENT OF TRANSPORTATION AND PUBLIC FACILITIES 2020 STANDARD SPECIFICATIONS FOR HIGHWAY CONSTRUCTION AND THE PROJECT MANUAL.

RECORD OF REVISIONS 500 DATE SER!

DESCRIPTION



DRAWN BY: . ROEMELING DESIGNED BY: ROFMFLING HECKED BY: . CHAMBERS 219 MAIN ST #13 HAINES, AK 99827 2201 DUNN STREET #2 JUNEAU, AK 99801

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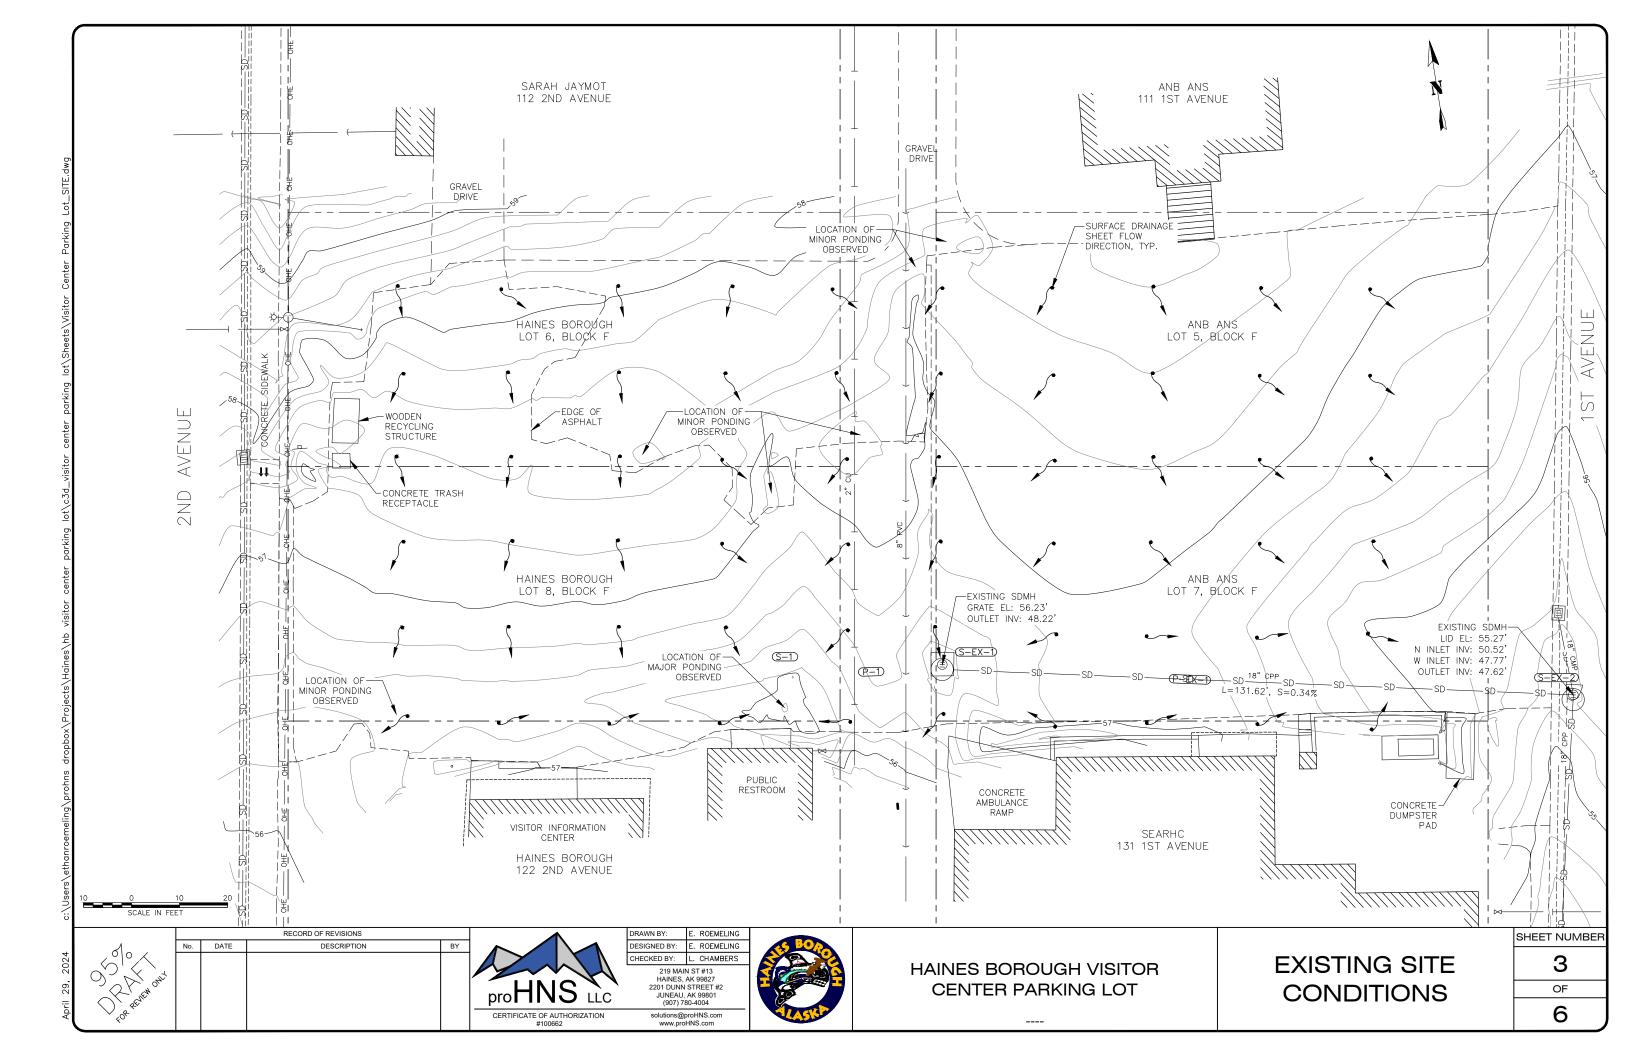



HAINES BOROUGH VISITOR **CENTER PARKING LOT** 

LEGEND **ABBREVIATIONS GENERAL NOTES**  SHEET NUMBER

OF

6



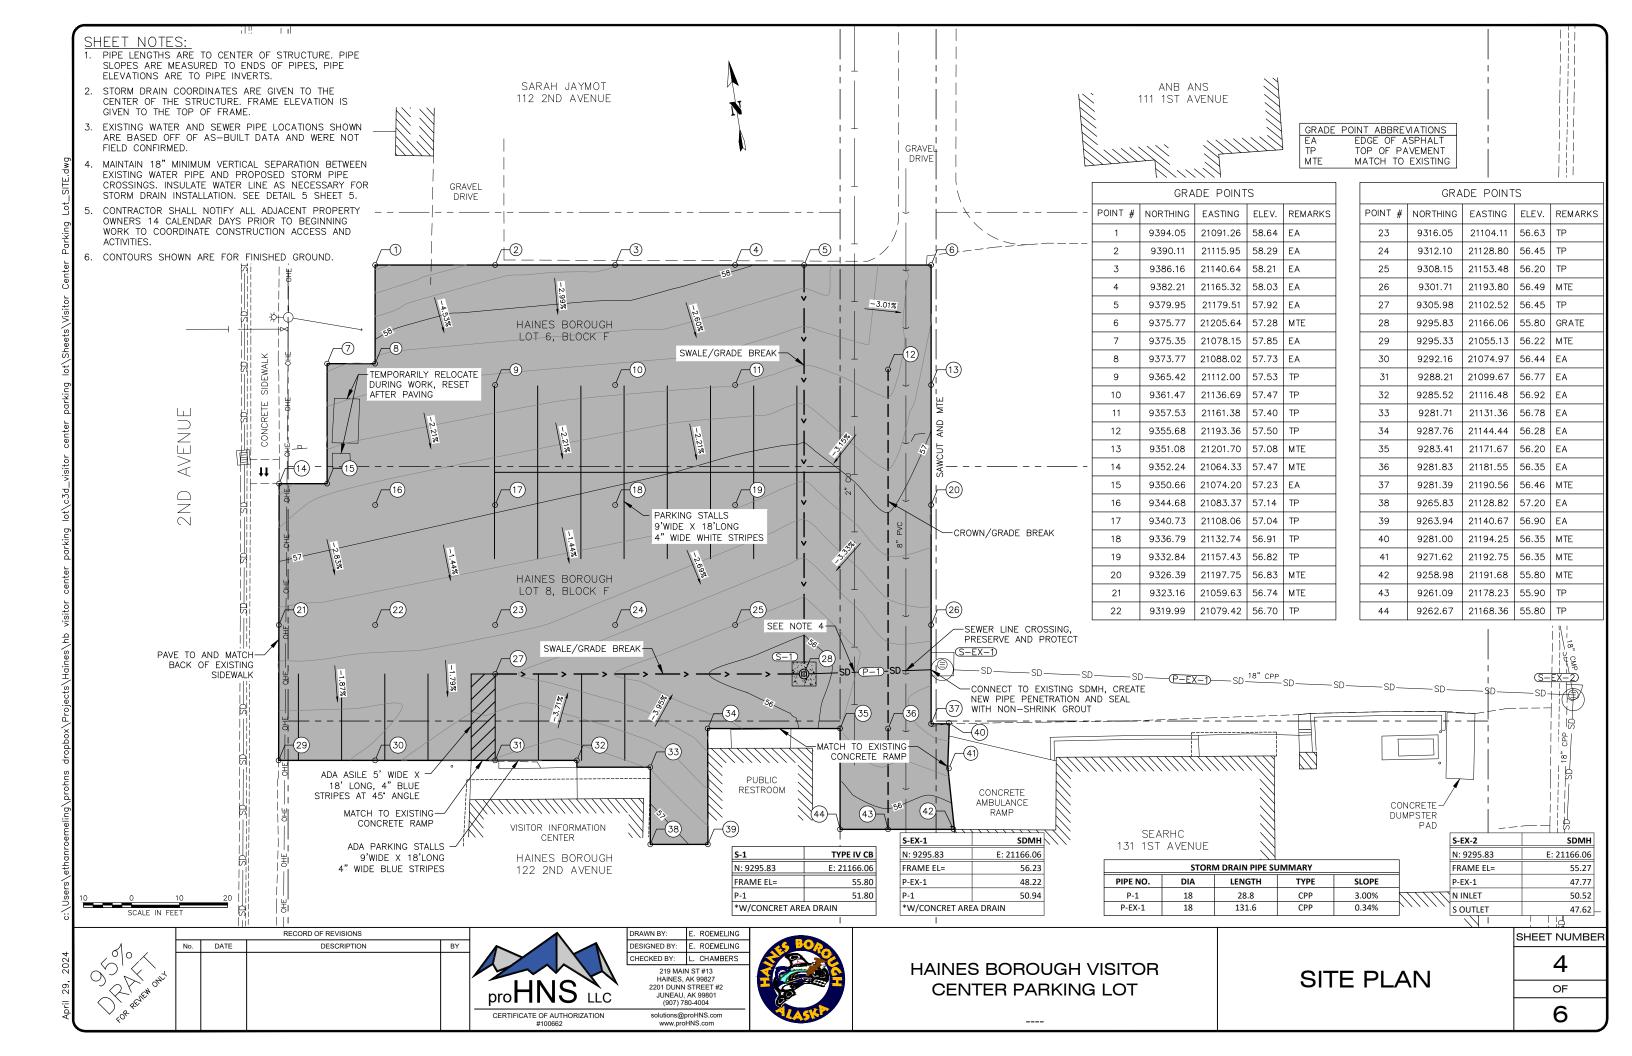




# PARKING AREA TYPICAL SECTION

SCALE: NOT TO SCALE


#### DETAIL 1/5 NOTES:

- 1. COMPACT D-1 BASE COURSE TO MINIMUM 95% OF MODIFIED PROCTOR DENSITY (ASTM D1557)
- 2. PROOF ROLL BOTTOM OF SUBCUT EXCAVATION SHALL BE PERFORMED USING A MINIMUM 10-TON SELF PROPELLED VIBRATORY COMPACTOR. A MINIMUM OF TWO (2) PASSES (ONE PASS EQUALS DOWN AND BACK) SHALL BE MADE OVER THE SUBCUT SOILS AND AS APPROVED BY THE ENGINEER.

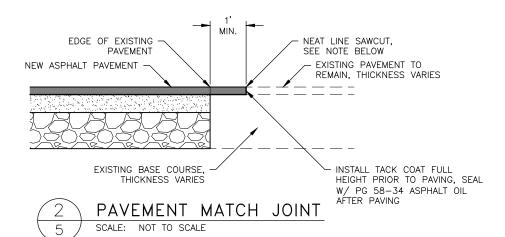


#### DETAIL 2/5 NOTES:


1. FINAL SAWCUT OF EXISTING ASPHALT SHALL NOT BE MADE UNTIL 24 HOURS PRIOR TO

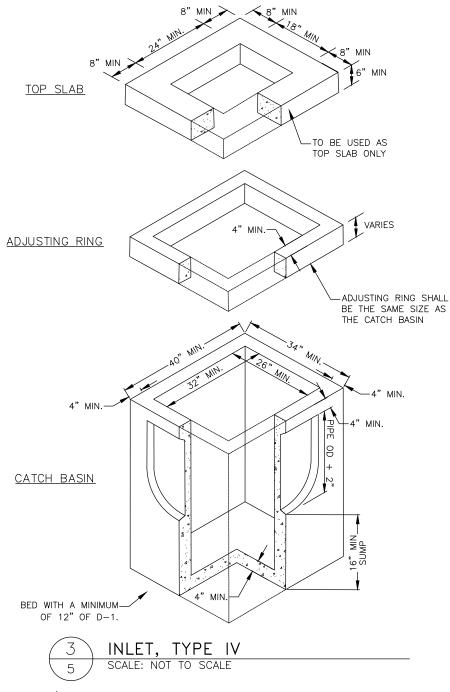


- 1. ENTIRE KNOCKOUT IS TO BE REMOVED AND SEALED SHUT AROUND PIPE. ALL PIPES ARE TO EXTEND MIN. 1" AND MAX. 2" INTO CATCH BASIN.
- THE AREA BETWEEN THE TOP OF THE CATCH BASIN AND THE FRAME SHALL BE FORMED AND FILLED WITH CONCRETE OR NON-SHRINK GROUT. NO BRICKS, WOOD OR OTHER MATERIALS PERMITTED FOR ADJUSTING GRADE.
- FRAME AND GRATE SHALL BE DUCTILE IRON. FRAME MAY BE CAST INTO THE TOP UNIT OR PLACED OVER THE OPENING AS APPROVED BY THE ENGINEER. FRAME AND GRATE MUST BE OF A TYPE THAT WILL NOT CREATE A HAZARD FOR BICYCLE TRAFFIC.
- 4. CATCH BASIN SHALL MEET HIGHWAY STANDARD-20 LOAD REQUIREMENTS
- 5. MINIMUM STEEL REQUIRED AS PER ASTM C-478-69.
- 6. MINIMUM SUMP DEPTH SHALL SHALL BE 16".

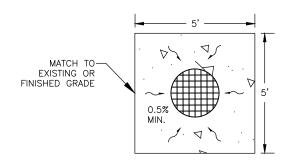

#### PLAN VIEW

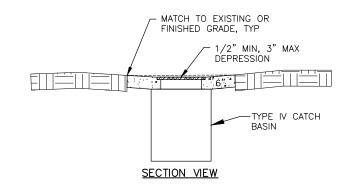

# CONCRETE AREA DRAIN DETAIL SCALE: NOT TO SCALE

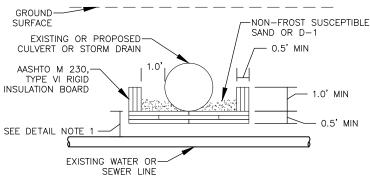

#### UTILITY CROSSING

## WATER LINE INSULATION DETAILS SCALE: NOT TO SCALE

#### DETAIL 5/5 NOTES:

- 1. INSTALL INSULATION AS SHOWN WHEN DISTANCE IS LESS THAN 6.0'.
- 2. PIPE INSULATION SHALL BE 8'-0" IN LENGTH, CENTERED OVER WATER LINE OR WATER SERVICE.
- 3. PIPE INSULATION WITH R-FACTOR EQUAL TO RIGID BOARD MAY BE SUBSTITUTED IF APPROVED BY THE ENGINEER.
- 4. CROSSING SHALL BE PROTECTED WITH A MINIMUM 6" OF INSULATION BOARDS WITH A 12" OVERLAP, AS SHOWN.

RECORD OF REVISIONS DATE DESCRIPTION OSK,



DRAWN BY: E. ROEMELING DESIGNED BY: E. ROEMELING HECKED BY: . CHAMBERS 219 MAIN ST #13 HAINES, AK 99827 2201 DUNN STREET #2

JUNEAU, AK 99801 (907) 780-4004

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HAINES BOROUGH VISITOR **CENTER PARKING LOT** 

CONSTRUCTION **DETAILS** 

SHEET NUMBER 5 OF

6



#### Haines Borough Planning Commission

# 12C

# **Draft Revision**

2024 Regular Planning Commission Meeting Agenda Preparation Calendar							
CUP, Variance, Platting Action, Rezone, Section Line and Easement Vacations Items due to Borough HBC 18.30.020 5:00 pm	CUP, etc.  Notice to CVN & Notification Letters out  5:00 pm	Other Agenda Topics & Borough Projects to Borough  (Must be to CVN for publication one week prior- HBC 18.20.020 HBC 18.30.040) 5:00 PM	PC Chair Approval - Agenda & Packet Documents FINAL <b>10:00am</b>	Agenda Packet Published & Distributed <b>5:00pm</b>	PC Meeting 6:30pm		
[Monday- <u>2 weeks</u> before PC Meeting week]	[To CVN Tuesday, mail out notices by Wednesday- 10 business days prior to PC Mtg]	[Monday – in newspaper <u><b>5 days</b></u> prior to PC Mtg]	[Wednesday prior to PC Mtg.]	[Friday prior to PC Mtg.]	2024		
Jun 3	Jun 5	Jun 10	Jun 12	Jun 14	Jun 20		
Jul 1	Jul 3	July 8	Jul 10	Jul 12	July 18		
Jul 29	Jul 31	Aug 5	Aug 7	Aug 9	Aug 15		
Sep 3*	Sep 4	Sept 9	Sep 11	Sep 13	Sep 19		
Sep 30	Oct 2	Oct 7	Oct 9	Oct 11	Oct 17		
Nov 4	Nov 6	Nov 12*	Nov 13	Nov 15	Nov 21		
Dec 2	Dec 4	Dec 9	Dec 11	Dec 13	Dec 19		

- \* Sept  $2^{nd}$  -->  $3^{rd}$  adjusted for Labor Day
- \* November 11<sup>th</sup> --> 12<sup>th</sup> adjusted for Veteran's Day



# Capital Improvement Projects (CIP) Six-Year Plan FY25-FY30

Year	Department/Facility	Description	Cost	Funding Source
FY25	Chilkat Center	·		
FY25	Downtown Core	Project, Sidewalk & Ramp Repairs  Conceptual Design, Haines Core Development Town Squar	\$15,000 \$30,000	
FY25	_	Project, Radio Site Modifications & Improvements	\$88,000	
FY25	Dispatch Facilities	•	,	
FY25	Fire HVFD	Sinking Fund, Deferred Maintenance	\$25,000	
FY25	Harbor	Sinking Fund, Equipment (SCBA 5 of 20)	\$14,000 \$5,000,000	
		Project, Replace Letnikof Float		
FY25	Harbor IT	Sinking Fund, Harbor Breakwater Anodes	\$30,000	
FY25		Project, IT Wireless Upgrades Phase II	\$15,000	
FY25	T T	Project, IT Firewall Replacement	\$22,000	
FY25	IT/Library	Project, Library Security Upgrades	\$46,000	ARPA
FY25	Parks	Conceptual Design, Ice Rink, Tennis, Pickle ball Court	\$35,000	
FY25	PC Dock	Design, Continue to Develop Floating Dock Design	\$100,000	
FY25	PC Dock	Project, Fender Refurbishment	\$498,000	CPV \$250K/Fund 94 \$248K SOA CPV Request \$1.1M
FY25	Public Works	Project, Covered Storage for PW Yard	\$34,000	CIP
FY25	Public Works	Project, Dalton Hill Repairs	\$427,574	FEMA
FY25	Public Works	Project, Cathedral View Drive	\$1,348,090	FEMA
FY25	Public Works	Project, Second Avenue	\$3,009,530	FEMA
FY25	Public Works	Project, Citywide Culverts & Minor Road Repairs	\$1,078,950	FEMA
FY25	<b>Public Works</b>	Project, Additional for 5th & 6th Ave Drainage	\$46,500	CIP
FY25	<b>Public Works</b>	Project, East Mathias Ave Realignment	\$385,000	CIP
FY25	Public Works	Project, Road Improvements	\$120,000	CIP
FY25	RMSA	Project, Matching Funds for RMSA Road Improvements	\$50,000	CIP
FY25	Sewer	Project, WWTP Influent Upgrade	\$1,876,000	DEC Loan/Grants
FY25	Sewer	Project, Implement Recommendations from I & I Study	\$50,000	CIP
FY25	Water	Project, Water Service & Main Repair / Upgrades	\$50,000	CIP
FY25	Sewer/Water	Project, Dalton Street Work Not Covered by FEMA	\$70,000	CIP
FY25	Water	Project, Piedad WTP Upgrades	\$25,000	
FY25	Water	Project, Lily Lake Treatment Plant Upgrade	\$1,300,000	DEC Loan/Grants
EVOC	Al. D. C.	D. C. F. ID. C. Al. C. Bill.	0000 000	CID
FY26	Admin Building	Design, Final Design Administration Bldg Expansion	\$200,000	
FY26	Admin Building	Purchase, Community Notification Sign to Publicize Meetin		CIP
FY26	Chilkat Center	Design, Chilkat Center HVAC	\$60,000	
FY26	Facilities	Sinking Fund, Building Improvements	\$100,000	
FY26	Facilities	Sinking Fund, Deferred Maintenance	\$25,000	
FY26	Facilities	Project, Lutak Storage Shed Finishing	\$100,000	
FY26	Fire HVFD	Purchase, Type 6 Wildland Fire Vehicle	\$150,000	-
FY26	Fire HVFD	Sinking Fund, Equipment (SCBA 6 of 20)	\$14,000	
FY26	Harbor	Sinking Fund, Harbor Breakwater Anodes	\$30,000	
FY26	Harbor	Engineering, Harbor Float / Drive Down 35% Design	\$500,000	9 9
FY26	Library	Purchase, One-man Bucket Electric Z Lift	\$50,000	
FY26	Parks	Project, Softball Field Improvements	\$474,000	CIP



# Capital Improvement Projects (CIP) Six-Year Plan FY25-FY30

Year	Department/Facility	Description	Cost	Funding Source
FY26	PC Dock	Design, Final Design Floating Dock	\$700,000	CPV/Grants/Port Fee
FY26	Police	Purchase, Police Patrol Vehicle	\$80,000	CIP
FY26	Pool	Project, Replace Pool Roof	\$250,000	CIP
FY26	Pool	Design, Pool HVAC Replacement	\$140,000	CIP
FY26	<b>Public Safety Bldg</b>	Project, Public Safety Building	\$31,100,000	CIP/Grants/Loans/Bonds
FY26	<b>Public Works</b>	Project, Road Improvements	\$200,000	CIP
FY26	Public Works	Project, Lily Lake Road	\$461,179	FEMA
FY26	Public Works	Sinking Fund, Heavy Equipment	\$160,000	CIP
FY26	Sewer	Project, Implement Recommendations from I & I Study	\$100,000	CIP/Enterprise Funds
FY26	Sewer	Project, Clarifier & Tank Reconditioning	\$560,000	CIP/Enterprise Funds
FY26	Sewer	Project, Beach Rd & 1 Mile Lift Station Aux. Power	\$460,000	CIP
FY26	Sewer/Water	Project, Water and Sewer Repairs/Upgrades	\$150,000	CIP
FY26	Water	Project, Water Lift Station Auxiliary Power	\$174,000	CIP
FY26	Water	Engineering, Hemlock Estates Water Main Loop	\$20,000	CIP
FY27	Admin Puilding	Draiget Administration Puilding Evangion		CIP/Grants
FY27	Admin Building Chilkat Center	Project, Administration Building Expansion	\$213,000	
FY27	Chilkat Center	Project, Chilkat Center Painting Sinking Fund, Chilkat Center HVAC Upgrade	\$220,000	
FY27	Facilities		\$25,000	
FY27	Fire HVFD	Sinking Fund, Maintenance Deferred Sinking Fund, Fire Truck	\$15,000	
FY27	Fire HVFD	Sinking Fund, Equipment (SCBA 7 of 20)	\$13,000	
FY27	Harbor	Sinking Fund, Harbor Breakwater Anodes	\$30,000	
FY27	Harbor	Project, Lutak Boat Ramp	\$150,000	
FY27	Harbor	Engineering, Harbor Float / Drive Down Full Design	\$750,000	
FY27 FY27	Parks	Project, Portage Cove Interpretive Trail 1 & 6a	\$896,000	
	PC Dock	Project, PC Floating Dock	\$10,000,000	
FY27	Pool	Project, HVAC Replacement	\$1,400,000	
FY27 FY27	Police	Design, Impound Yard	\$52,520	
FY27	Public Works	Purchase, Excavator	\$120,000	
FY27	Public Works	Project, Road Improvements	\$200,000	
	Public Works	Sinking Fund, Heavy Equipment Project, Locker Room Remodel	\$160,000	
FY27	School		\$1,000,000	
FY27	School	Project, Soccer Field Lift	\$75,000	
FY27	Sewer	Project, Implement Recommendations from I & I Study	\$100,000	•
FY27	Sewer/Water	Project, Water and Sewer Repairs/Upgrades	\$150,000	
FY27	Water	Project, Extend Water Main Small Tracts	\$1,890,000	
FY27	Water	Project, Well Field Auxiliary Power	\$115,000	CIP
FY28	Chilkat Center	Sinking Fund, Chilkat Center HVAC Upgrade	\$220,000	СІР
FY28	Facilities	Sinking Fund, Deferred Maintenance	\$25,000	
FY28	Fire HVFD	Sinking Fund, Fire Truck	\$15,000	
FY28	Fire HVFD	Sinking Fund, Equipment (SCBA 8 of 20)	\$14,000	

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# Capital Improvement Projects (CIP) Six-Year Plan FY25-FY30

Year	Department/Facility	Description	Cost	Funding Source		
FY28	Harbor	Project, Drive Down Work Float and Transfer Bridge	\$8,200,000	DOT/Harbor Fund/CIP		
FY28	Parks	Project, Ice Rink/Tennis/Pickle ball Court	\$1,000,000	CIP/Grants		
FY28	Police	Purchase, Police Patrol Vehicle	\$85,000	CIP		
FY28	<b>Public Works</b>	Project, Road Improvements	\$200,000	CIP		
FY28	<b>Public Works</b>	Sinking Fund, Heavy Equipment	\$165,000	CIP		
FY28	Sewer	Project, Implement Recommendations from I & I Study	\$100,000	CIP/Enterprise Funds		
FY28	Sewer	Project, Highland Estates Sewer Extension	\$935,000	LID/CIP/DEC Loan		
FY28	Sewer/Water	Project, Water and Sewer Repairs/Upgrades	\$150,000	CIP		
FY28	Water	Project, Water Line - FAA/Mt Riley	\$1,000,000	DEC/LID/CIP		
FY29	Facilities	Sinking Fund, Deferred Maintenance	\$25,000	CIP		
FY29	Fire HVFD	Sinking Fund, Fire Truck	\$15,000	CIP		
FY29	Fire HVFD	Sinking Fund, Equipment (SCBA 9 of 20)	\$15,000	CIP		
FY29	Harbor	Sinking Fund, Harbor Breakwater Anodes	\$30,000	CIP		
FY29	<b>Public Works</b>	Project, Road Improvements	\$200,000	CIP		
FY29	<b>Public Works</b>	Sinking Fund, Heavy Equipment	\$170,000	CIP		
FY29	Sewer/Water	Project, Water and Sewer Repairs/Upgrades	\$150,000	CIP		
FY30	г	C. I. T. I.D.C. IM.	007.000	CID		
FY30	Facilities	Sinking Fund, Deferred Maintenance	\$25,000			
	Fire HVFD	Sinking Fund, Fire Truck	\$15,000			
FY30	Fire HVFD	Sinking Fund, Equipment (SCBA 10 of 20)	\$15,000			
FY30	Harbor	Sinking Fund, Harbor Breakwater Anodes	\$30,000			
FY30	Police	Purchase, Police Patrol Vehicle	\$90,000	CIP		
FY30	Public Works	Project, Road Improvements	\$200,000	CIP		
FY30	Public Works	Sinking Fund, Heavy Equipment	\$176,000	CIP		
FY30	Sewer/Water	Project, Water and Sewer Repairs/Upgrades	\$150,000	CIP		

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12E



# Haines Borough

Planning and Zoning

103 Third Ave. S., Haines, Alaska, 99827 Telephone: (907) 766-6401 \* Fax: (907) 766-2716

#### LAND USE PERMIT APPLICATION

24-24

			\$50 Non-Refunda	able Fee	Permit #	21 21
I. Owner/Authorized Re	presentative	0	wner's Contract	or(If Any)		
Na <u>me</u> :			ame:			
JOANNE WA	TERMAN	Н	aines Borough E	Business L	icense #:	
Mailing Address:			Alaska Business License #:			
Box 853	3	С	ontractor's Licer	ise #:		
Contact Phone: Day	Night	M	ailing Address:			
Contact Phone: Day	3-7000	-	ontact Phone:	Day	Night	
Fax:					3	
		F	ax:			
E-mail:			-mail:			
a		-	mam			
II. Property Information		7		C'Stoller		
Property Tax ID #:	C-PTC-OR	3-0	100			
Size of Property;						
Site Street Address: (If	Any) SEWARD Dr.					
Legal Description: Lot			Cubdivision			
	(S)BIOCK_		Subdivision_			
OR						
Parcel/T	ract Section	n	Township_	F	Range	
[Attach additional sheets i	f necessary.]					
Zoning:   Waterfront   S	ingle Residential □Rural Re	esidential	Significant Structu	ıres ∆rea ⊓	Rural Mixed Use	□Multiple
Residential pHeavy Industrial			<b>/</b> )			ar raidpic
	District Lutak Zoning Dist		_	Joinner Clar L	INCCI CALIONAL	
III. Description of Work		No. Co.		THE PARTY OF THE P	VALUE OF THE VEN	72 3335
Type of Application	Project Descripti	on	Water Supply		Sowage Diene	cal
(Check all that apply)	(Check all that apply		Water Supply Existing or Pro		Sewage Dispo Existing or Prop	CONTRACTOR OF
Residential	Single Family Dwell		□None	poseu	□None	oseu
Commercial	□Change of Use	ing	□Community we	Ш	□Septic Tank	
sa. ft.	□Multi-Family Dwellir	าต	□Private well	:11	□Holding Tank	
	Total # of Units		□Public Water		□Public Sewer	
seating capacity if eating/drinking	□Cabin		□ Other		□ Pit Privy	
establishment	□Addition		b odici		□Composting Toi	let
□Industrial	XAccessory Structure	2			□Other	icc
DChurch	Other					
oOther						
Estimate Cost of Work:  Land Use Requested For:  Wood Shed						
\$400.00		(Desci	ibe the project, a	nd use add	ditional sheets if ne	cessary)
Required Attachments:	Site plan (see Attach		-			
	\$50 Non-Refundable Fee (Checks must be made payable to the Haines Borough)					
Don UDC 13 00 100 3 10	60.010.75		ah a was ta was	and to solve t	- 200 ft-f	!
Per HBC 13.08.100 and 18						
adequate public water and Failure to connect will resu				nea to con	mect to the public s	ystems.
I WINNIE TO COMMICCE ANIM LESS	are in a minior offense s	anlerr	to penanties.			

#### IV. CERTIFICATION

I hereby certify that I am the owner or authorized representative of the property described above and that I petition for a land use permit in conformance with all of the provisions in the Haines Borough Code. I also certify that the site plan submitted is a complete and accurate plan showing any and all existing and proposed structures on the subject property. I understand that payment of the application fee is nonrefundable and is to cover the costs associated with processing this application, and that it does not assure approval of the proposed use. I also understand that all contract work on this project will be done by a contractor holding valid licenses issued by the State of Alaska and the Haines Borough.

I am aware that if I begin work prior to receiving permit approval, I may be assessed a penalty fee, as per HBC 18.30.070. I am also aware that my property will be inspected throughout the duration of the permit to calculate percent complete and valuation of improvements.


Joanne h. Waterman	MAY 2, 2024
Signature (Representatives must provide written proof of authorization)	Date

PROVISIONS: The applicant is advised that issuance of this permit will not relieve responsibility of the owner or authorized representative to comply with the provisions of all laws and ordinances, including federal, state and local jurisdictions, which regulate construction and performance of construction, or with any private deed restrictions.

Office Use Only Below This Line Non-Refundable Application Fee Application is Complete: Yes No Payment Method: Notified Via: Notified By: Receipt #: Date: Received By: Borough Business License # Date: (If applicable) If application is **approved**: If application is **denied**: Approved By: Denied By: Borough Manager/Designee Borough Manager/Designee Reason:\_\_\_\_\_ Permit ID #: Date: Permit Effective Date: \_\_\_\_\_

Notice of Right to Appeal: All decisions of the Borough Officials are appealable per HBC 18.30.050

#### INCOMPLETE APPLICATIONS WILL NOT BE ACCEPTED

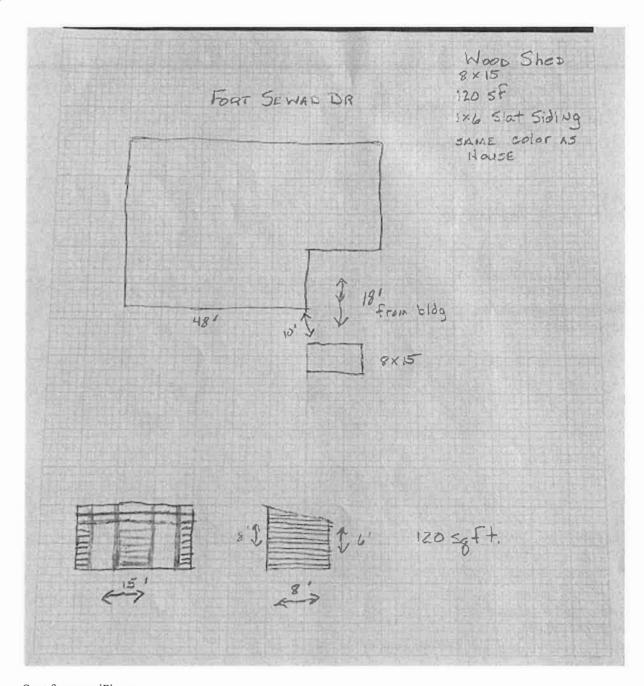

Sent from my iPhone

- 2. The use of the dwelling unit or detached appurtenance for the home occupation is clearly incidental and subordinate to its use for residential purposes by its occupants, and not more than 30 percent of the combined floor area of the dwelling and appurtenance is used in the conduct of the home occupation;
- 3. There is no significant change in the outside appearance of the building or premises or other visible evidence of the conduct of such home occupation other than one sign, not exceeding four square feet in area, nonanimated and nonilluminated and mounted flat against the wall of the principal building;
- 4. No noise or odors not normally expected from a dwelling unit will be allowed as a result of the operation of the home occupation;
- 5. Traffic or a need for parking is not generated by such home occupation in significantly greater volumes than would normally be expected in a similar residential neighborhood;
- 6. Outdoor storage of materials or equipment will not be allowed unless adequately screened.
- E. Bed and Breakfast (B&B). A bed and breakfast may be allowed as an accessory to a residential use; provided, that the use of the dwelling unit for the B&B is clearly incidental and subordinate to the use of the dwelling as a residence by its owners or a manager living on-site. One sign, not exceeding four square feet in area, illuminated by indirect lighting and on the same lot as the B&B use is allowed.
- F. *Kennel*. A kennel may be allowed if a site plan is approved and the kennel building, dog runs or other outside canine housing area is separated from any residential zoned lot line by a minimum of 50 feet.
- G. *Historic Buildings*. All development occurring within the significant structures area, or changes to any of the surveyed historic buildings, shall comply with specific requirements. When the commission determines that the development is one of the surveyed historic structures or the development has a material effect upon the general character of the district and any of the individual structures therein, the following shall apply:
  - 1. Every reasonable effort shall be made to provide a compatible use for property that requires minimal alterations of the building, structure, or site and its environment, or to use a property for its originally intended purpose.
  - 2. The developer shall be encouraged to retain the distinguishing original qualities or character of a building, structure, or site and its environment. The removal or alteration of any historic material or distinctive architectural features should be avoided whenever possible.
  - 3. Changes which may have taken place in the course of time are evidence of the history and development of a building, structure, or site and its environment. These changes may have acquired significance in their own right, and this significance shall be recognized and respected.
  - 4. Distinctive stylistic features or examples of skilled craftsmanship that characterize a building, structure or site, shall be treated with sensitivity.
  - 5. Deteriorated architectural features shall be repaired rather than replaced whenever possible. In the event replacement is necessary, the new materials should match the material being replaced in composition,

design, color, texture and other visual qualities wherever possible. Repair or replacement of missing architectural features should be based on accurate duplications rather than on conjectural designs or the availability of different architectural elements from other buildings or structures.

- 6. Every reasonable effort shall be made to protect and preserve archeological resources affected by, or adjacent to any rehabilitation project.
- 7. Contemporary design and use of contemporary materials for alterations and additions to existing buildings and properties shall not be discouraged when such alterations and additions do not destroy significant historical, architectural, or cultural material, and such design is compatible with the size, scale, color, and character of the property, neighborhood or environment.
- 8. Wherever possible, additions or alterations to structures shall be done in such a manner that if such additions or alterations were to be removed in the future, the essential form and integrity of the structure should not be impaired.
- 9. The commission shall have the authority to place design standards and requirements upon the developer prior to the issuance of the permit in order to enforce the historic preservation and rehabilitation standards herein. A design review committee may be appointed by the planning commission which shall consist of the following representatives: the planning commission chair, a planning commission member appointed by the commission, one member of the borough assembly as appointed by the assembly, and one at-large member who is a property owner in the SSA, appointed by the commission chair, specific to each application. The commission shall refer to the document "Fort William H. Seward, Haines, Alaska, Design Guidelines and Standards" prepared by Ron Kasprisin of the Alaskan Northern Studies Program, Department of Urban Design and Planning, University of Washington, Seattle, 1998, when setting out the design standards to be followed for buildings in the significant structures area. (See also HBC 18.70.050.)
- H. *Temporary Residence*. Persons desiring to place a temporary residence, or a trailer or mobile home or RV outside of a mobile home or RV park in the townsite service area for a temporary or interim occupancy over 30 days, shall apply for a temporary residence permit. The intent of a temporary residence permit is to allow a temporary structure for residential use. This means one trailer, RV or mobile home may be occupied during construction of a permanent structure. A temporary residence permit may be granted if all of the following requirements are met:
  - 1. A valid permit for the permanent structure must be in effect during the entire time that the temporary dwelling is located on the site;
  - 2. A trailer, RV or mobile home used as a temporary dwelling during the construction of a permanent structure must be located on the same lot or parcel;
  - 3. The temporary dwelling must be transported to a sanitary dump station as needed to empty gray water and toilet waste tanks, be connected to public water and sewer if applicable, or be serviced by an approved DEC on-site wastewater system;
  - 4. The temporary dwelling must meet the same setbacks applicable to permanent structures;

Please see the following links attached below under web links for the historic structures history:

Fort Seward Design Guidelines and Standards https://www.hainesalaska.gov/planningzoning/fort-seward-design-guidelines-standards

Building History - Survey of Historic Structures

https://www.hainesalaska.gov/sites/default/files/fileattachments/comprehensive\_plan\_2025/page/1486/building\_history\_survey\_of\_historic\_structures\_city\_of\_haines.pdf